Roof Recovery Collin County Justice Center 4300 Community Ave. McKinney, Texas

E1.0 EXTERIOR ELEVATIONS KEYPLAN

E1.1 EXTERIOR ELEVATIONS

E1.2 EXTERIOR ELEVATIONS

E1.3 EXTERIOR ELEVATIONS

E1.4 EXTERIOR ELEVATIONS

Index of drawings

Project Team

D1.0 OVERALL ROOF DEMO KEYPLAN

D1.1 DEMO PLAN- AREAS A1-A8

D1.2 DEMO PLAN- AREAS B1-B10

D1.3 DEMO PLAN- AREAS C1-C8

D1.4 DEMO PLAN- AREAS D1-D6

D1.5 DEMO PLAN- AREAS D1, D6, D7 AND D8

D1.6 DEMO PLAN- AREAS D9, D10

R1.0 OVERALL ROOF KEYPLAN

R1.1 ROOF PLAN- AREAS A1-A8

R1.2 ROOF PLAN- AREAS B1-B10

R1.3 ROOF PLAN- AREAS C1-C8

R1.4 ROOF PLAN- AREAS D1-D6

R1.5 ROOF PLAN- AREAS D1, D6, D7 AND D8

R1.6 ROOF PLAN- AREAS D9, D10

R1.7 ROOF DETAILS

R1.8 ROOF DETAILS

Owner:

Collin County, Texas

Consultant:

DryTec Moisture Protection Technology Consultants, Inc. 8750 North Central Expressway Suite 1730


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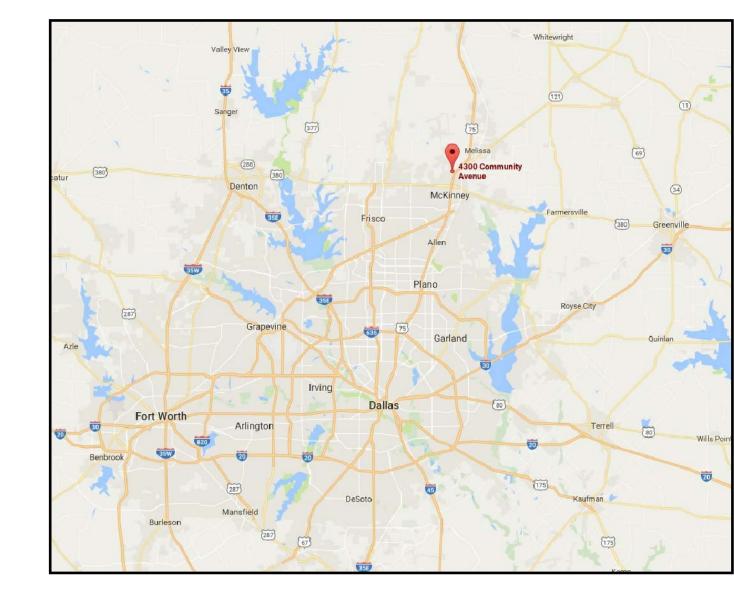
Issue for Construction 08-28-17 Addendum 2 10-13-17

General Information


• PLEASE REFER INFRARED MOISTURE SCAN REPORT DATED 05-24-17. THERE ARE MULTIPLE ROOF AREAS SHOWN THAT APPEAR TO HAVE MOISTURE-DAMAGED ROOF INSULATION UNDERNEATH THE EXISTING ROOF MEMBRANE. THESE AREAS ARE NOTED ON THE DEMOLITION PLANS. FOR BIDDING PURPOSES, ASSUME 30% OF THE EXISTING ROOFING AND INSULATION WILL BE REMOVED AND REPLACED. LOG THE AMOUNT REPLACED DAILY AND UPON COMPLETION THE CONSTRUCTION COST WILL BE ADJUSTED BASED ON THE ACTUAL PERCENTAGE REPLACED. REFER BID DOCUMENTS FOR FURTHER INFORMATION.




Area Map

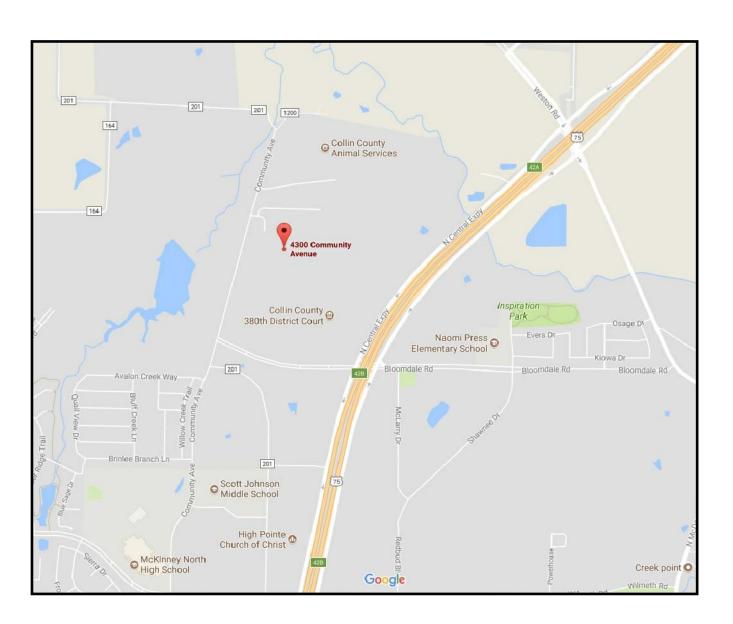

Location Map

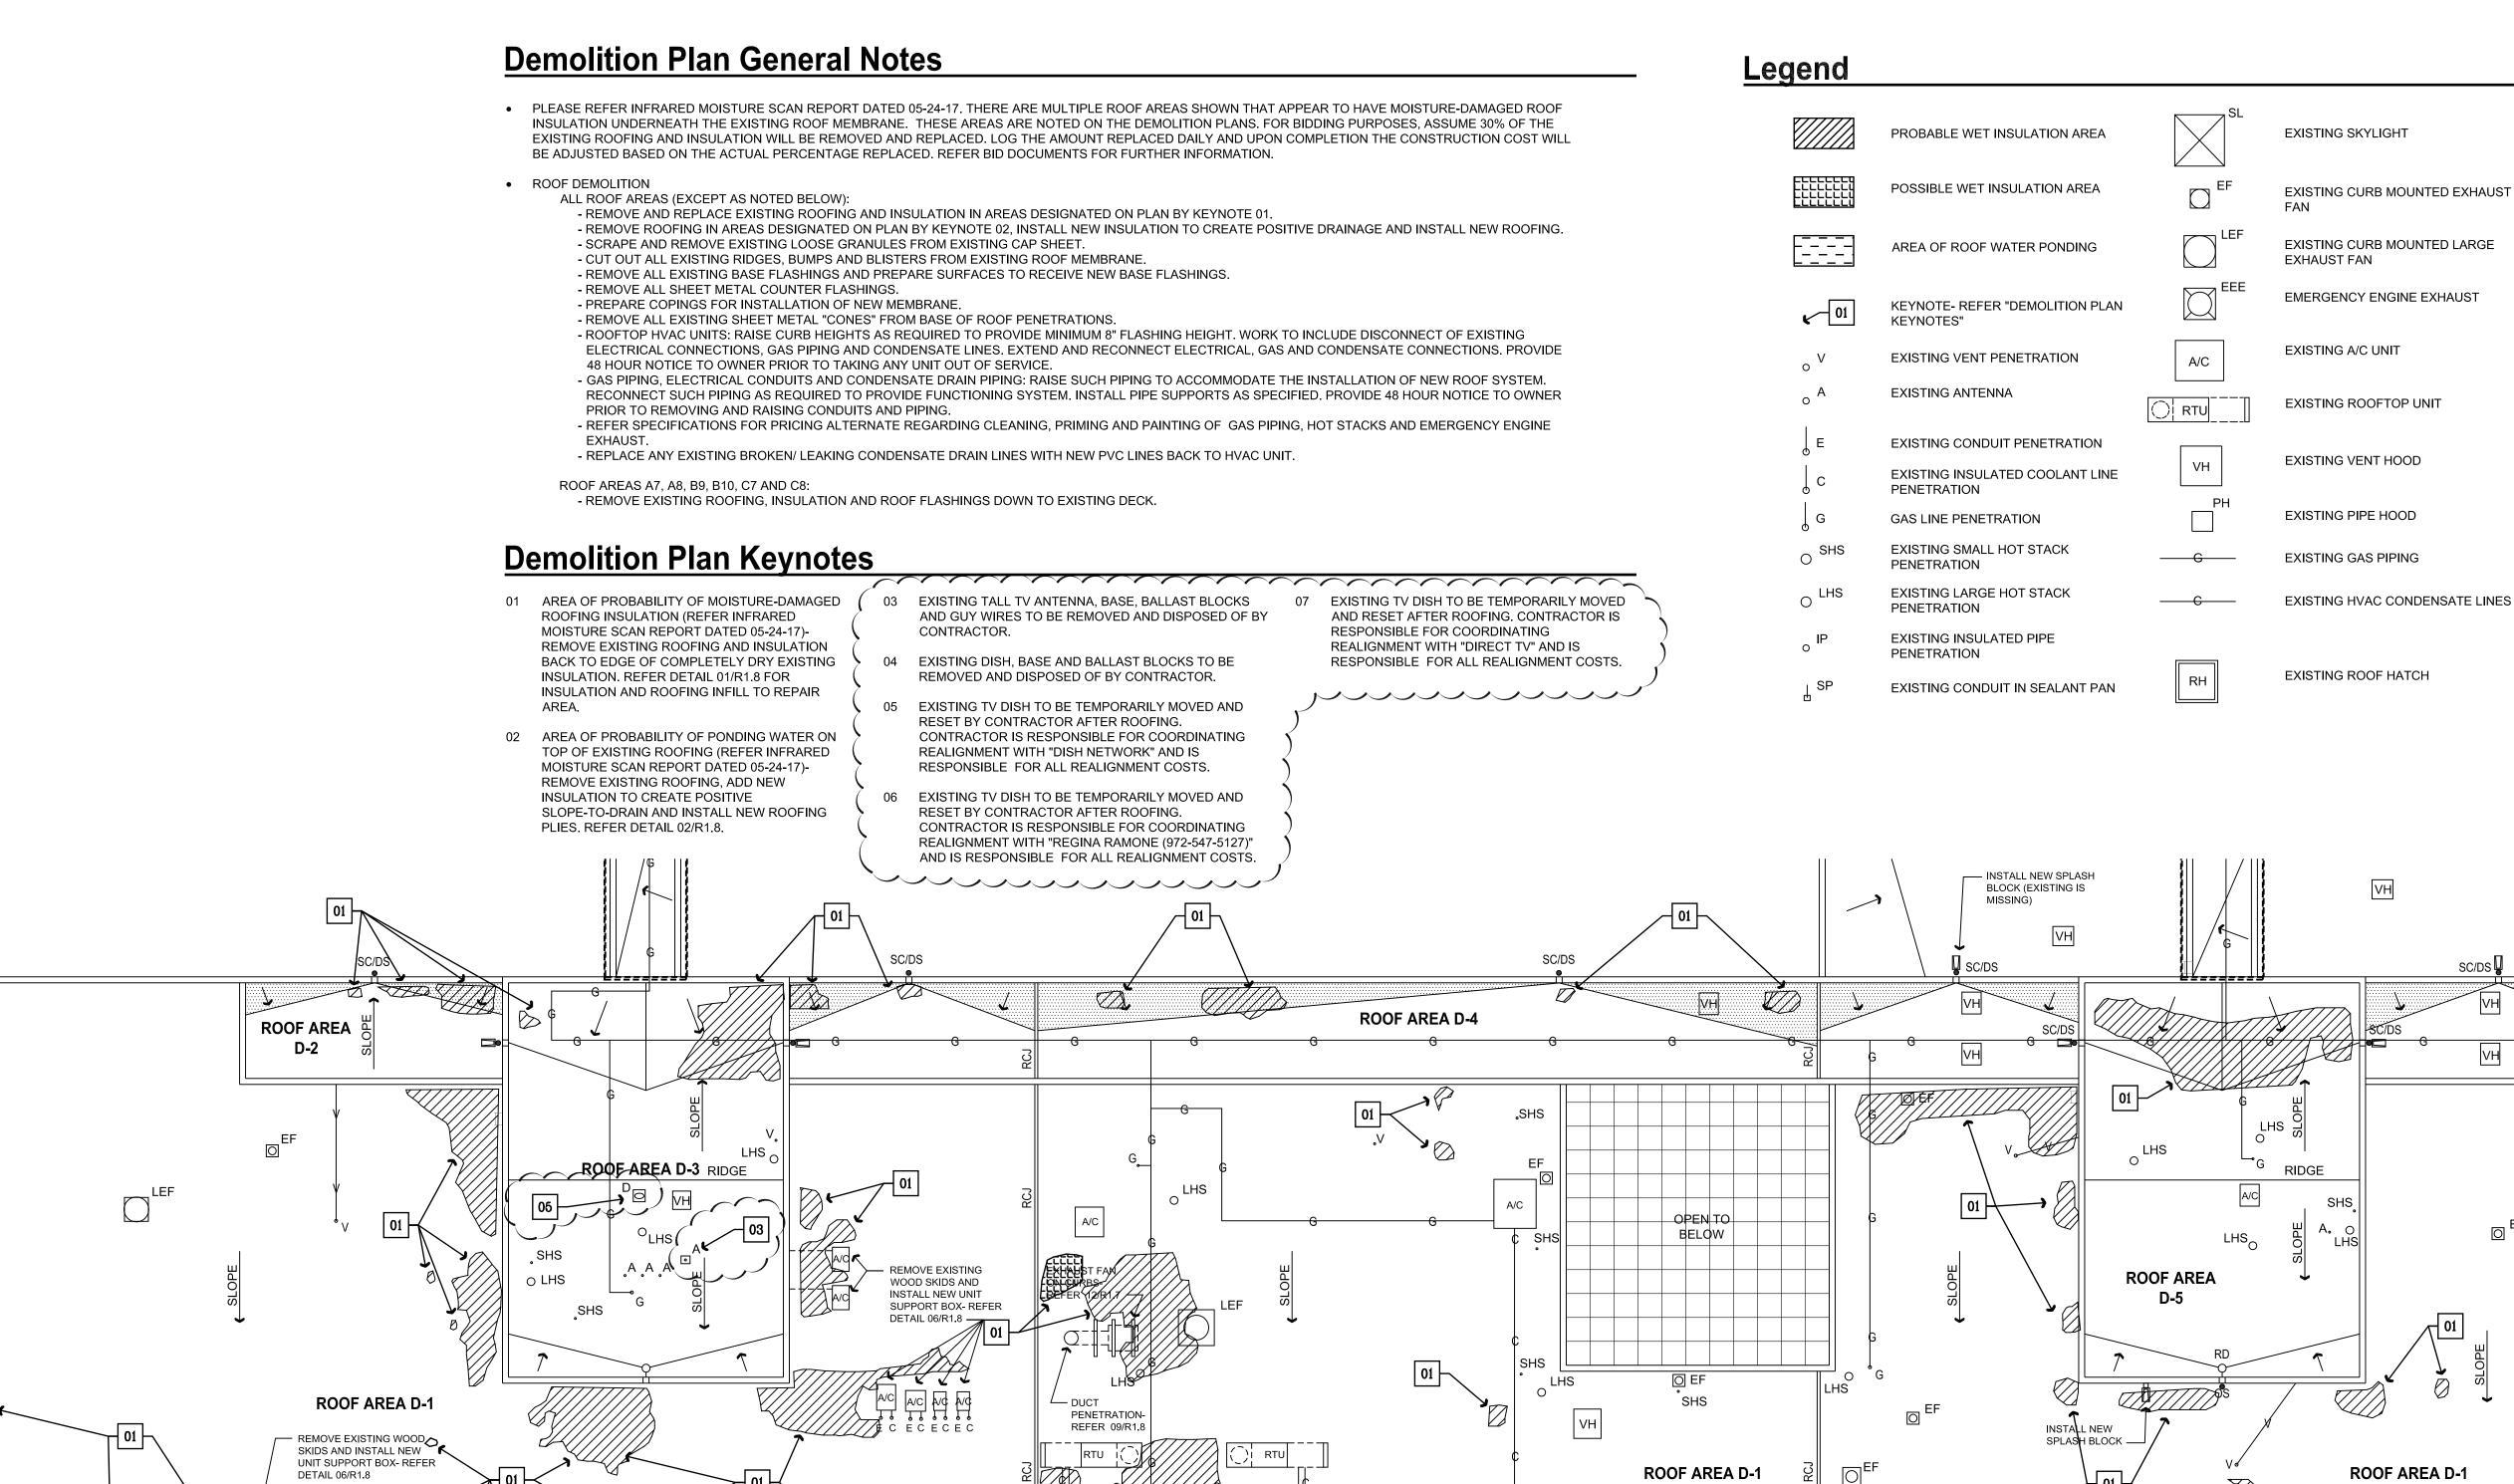

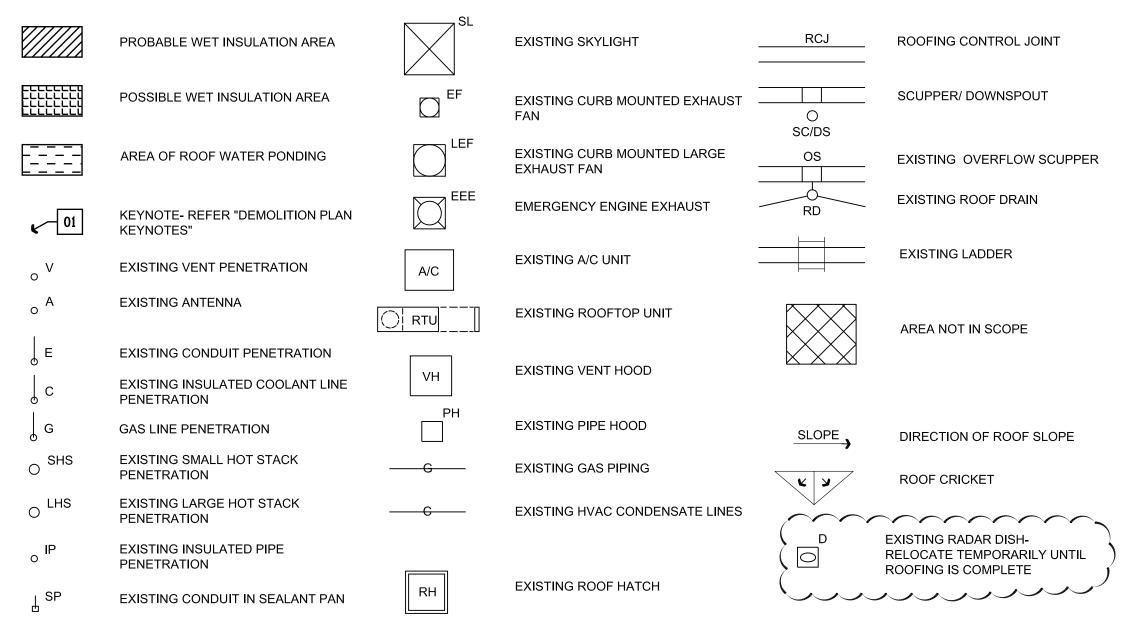

ROOF AREA

SLOPE
 SLOPE

Technology Consultants, Inc. 8750 N. Central Expwy, Suite 1730 Dallas, Texas



Date of Signing October 13, 2017

BELOW

ADDENDUM 2

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Sheet Title Demo Plan-Areas D1-D6

Project Number 46-17026N AS NOTED 08/28/17

Demolition Plan General Notes


- PLEASE REFER INFRARED MOISTURE SCAN REPORT DATED 05-24-17. THERE ARE MULTIPLE ROOF AREAS SHOWN THAT APPEAR TO HAVE MOISTURE-DAMAGED ROOF. INSULATION UNDERNEATH THE EXISTING ROOF MEMBRANE. THESE AREAS ARE NOTED ON THE DEMOLITION PLANS. FOR BIDDING PURPOSES, ASSUME 30% OF THE EXISTING ROOFING AND INSULATION WILL BE REMOVED AND REPLACED. LOG THE AMOUNT REPLACED DAILY AND UPON COMPLETION THE CONSTRUCTION COST WILL BE ADJUSTED BASED ON THE ACTUAL PERCENTAGE REPLACED. REFER BID DOCUMENTS FOR FURTHER INFORMATION.
- ROOF DEMOLITION
- ALL ROOF AREAS (EXCEPT AS NOTED BELOW):
 - REMOVE AND REPLACE EXISTING ROOFING AND INSULATION IN AREAS DESIGNATED ON PLAN BY KEYNOTE 01. - REMOVE ROOFING IN AREAS DESIGNATED ON PLAN BY KEYNOTE 02, INSTALL NEW INSULATION TO CREATE POSITIVE DRAINAGE AND INSTALL NEW ROOFING. - SCRAPE AND REMOVE EXISTING LOOSE GRANULES FROM EXISTING CAP SHEET.
 - CUT OUT ALL EXISTING RIDGES, BUMPS AND BLISTERS FROM EXISTING ROOF MEMBRANE.
 - REMOVE ALL EXISTING BASE FLASHINGS AND PREPARE SURFACES TO RECEIVE NEW BASE FLASHINGS.
- REMOVE ALL SHEET METAL COUNTER FLASHINGS. - PREPARE COPINGS FOR INSTALLATION OF NEW MEMBRANE.
- REMOVE ALL EXISTING SHEET METAL "CONES" FROM BASE OF ROOF PENETRATIONS.
- ROOFTOP HVAC UNITS: RAISE CURB HEIGHTS AS REQUIRED TO PROVIDE MINIMUM 8" FLASHING HEIGHT. WORK TO INCLUDE DISCONNECT OF EXISTING ELECTRICAL CONNECTIONS, GAS PIPING AND CONDENSATE LINES. EXTEND AND RECONNECT ELECTRICAL, GAS AND CONDENSATE CONNECTIONS. PROVIDE
- 48 HOUR NOTICE TO OWNER PRIOR TO TAKING ANY UNIT OUT OF SERVICE. - GAS PIPING, ELECTRICAL CONDUITS AND CONDENSATE DRAIN PIPING: RAISE SUCH PIPING TO ACCOMMODATE THE INSTALLATION OF NEW ROOF SYSTEM. RECONNECT SUCH PIPING AS REQUIRED TO PROVIDE FUNCTIONING SYSTEM. INSTALL PIPE SUPPORTS AS SPECIFIED. PROVIDE 48 HOUR NOTICE TO OWNER
- PRIOR TO REMOVING AND RAISING CONDUITS AND PIPING. - REFER SPECIFICATIONS FOR PRICING ALTERNATE REGARDING CLEANING, PRIMING AND PAINTING OF GAS PIPING, HOT STACKS AND EMERGENCY ENGINE
- REPLACE ANY EXISTING BROKEN/ LEAKING CONDENSATE DRAIN LINES WITH NEW PVC LINES BACK TO HVAC UNIT.
- ROOF AREAS A7, A8, B9, B10, C7 AND C8:
- REMOVE EXISTING ROOFING, INSULATION AND ROOF FLASHINGS DOWN TO EXISTING DECK.


- THIS AREA NOT IN CONTRACT

Demolition Plan Keynotes

- 01 AREA OF PROBABILITY OF MOISTURE-DAMAGED ROOFING INSULATION (REFER INFRARED MOISTURE SCAN REPORT DATED 05-24-17)-REMOVE EXISTING ROOFING AND INSULATION BACK TO EDGE OF COMPLETELY DRY EXISTING INSULATION. REFER DETAIL 01/R1.8 FOR INSULATION AND ROOFING INFILL TO REPAIR
- 02 AREA OF PROBABILITY OF PONDING WATER ON TOP OF EXISTING ROOFING (REFER INFRARED MOISTURE SCAN REPORT DATED 05-24-17)-REMOVE EXISTING ROOFING, ADD NEW INSULATION TO CREATE POSITIVE SLOPE-TO-DRAIN AND INSTALL NEW ROOFING PLIES. REFER DETAIL 02/R1.8.
- 03 EXISTING TALL TV ANTENNA, BASE, BALLAST BLOCKS AND GUY WIRES TO BE REMOVED AND DISPOSED OF BY 04 EXISTING DISH, BASE AND BALLAST BLOCKS TO BE REMOVED AND DISPOSED OF BY CONTRACTOR.
- 05 EXISTING TV DISH TO BE TEMPORARILY MOVED AND RESET BY CONTRACTOR AFTER ROOFING. CONTRACTOR IS RESPONSIBLE FOR COORDINATING REALIGNMENT WITH "DISH NETWORK" AND IS RESPONSIBLE FOR ALL REALIGNMENT COSTS.
- 06 EXISTING TV DISH TO BE TEMPORARILY MOVED AND RESET BY CONTRACTOR AFTER ROOFING. CONTRACTOR IS RESPONSIBLE FOR COORDINATING REALIGNMENT WITH "REGINA RAMONE (972-547-5127)" AND IS RESPONSIBLE FOR ALL REALIGNMENT COSTS.
- 07 EXISTING TV DISH TO BE TEMPORARILY MOVED AND RESET AFTER ROOFING. CONTRACTOR IS RESPONSIBLE FOR COORDINATING REALIGNMENT WITH "DIRECT TV" AND IS
- RESPONSIBLE FOR ALL REALIGNMENT COSTS.

Legend

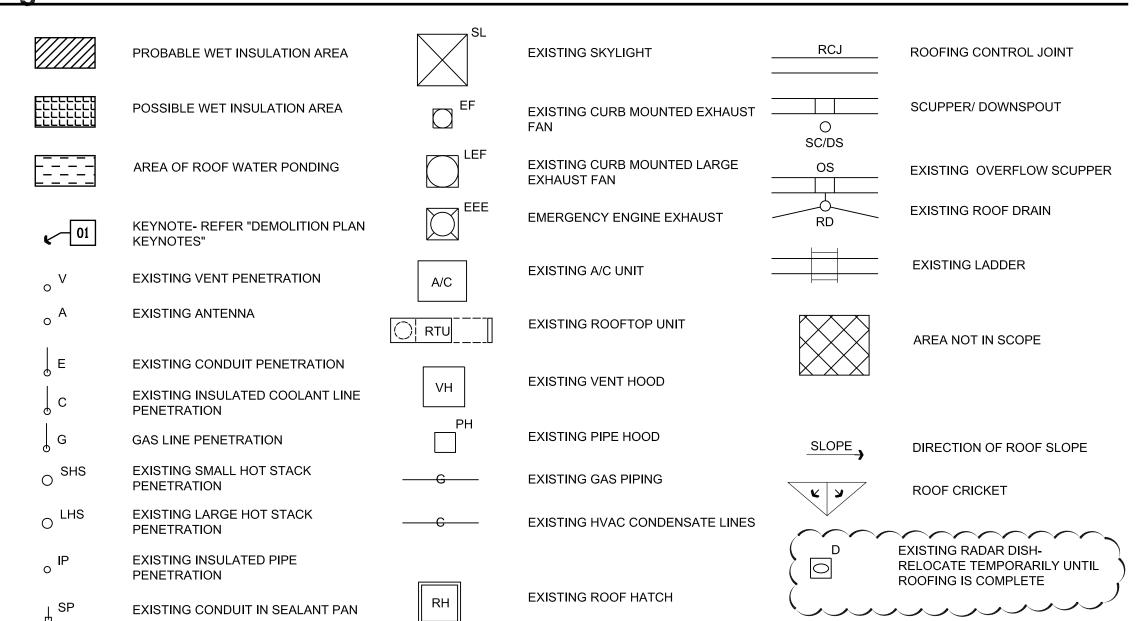

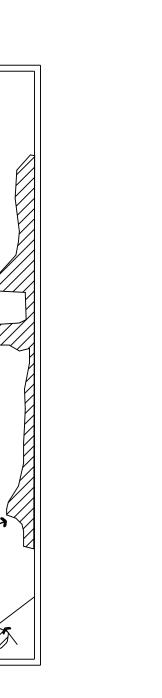

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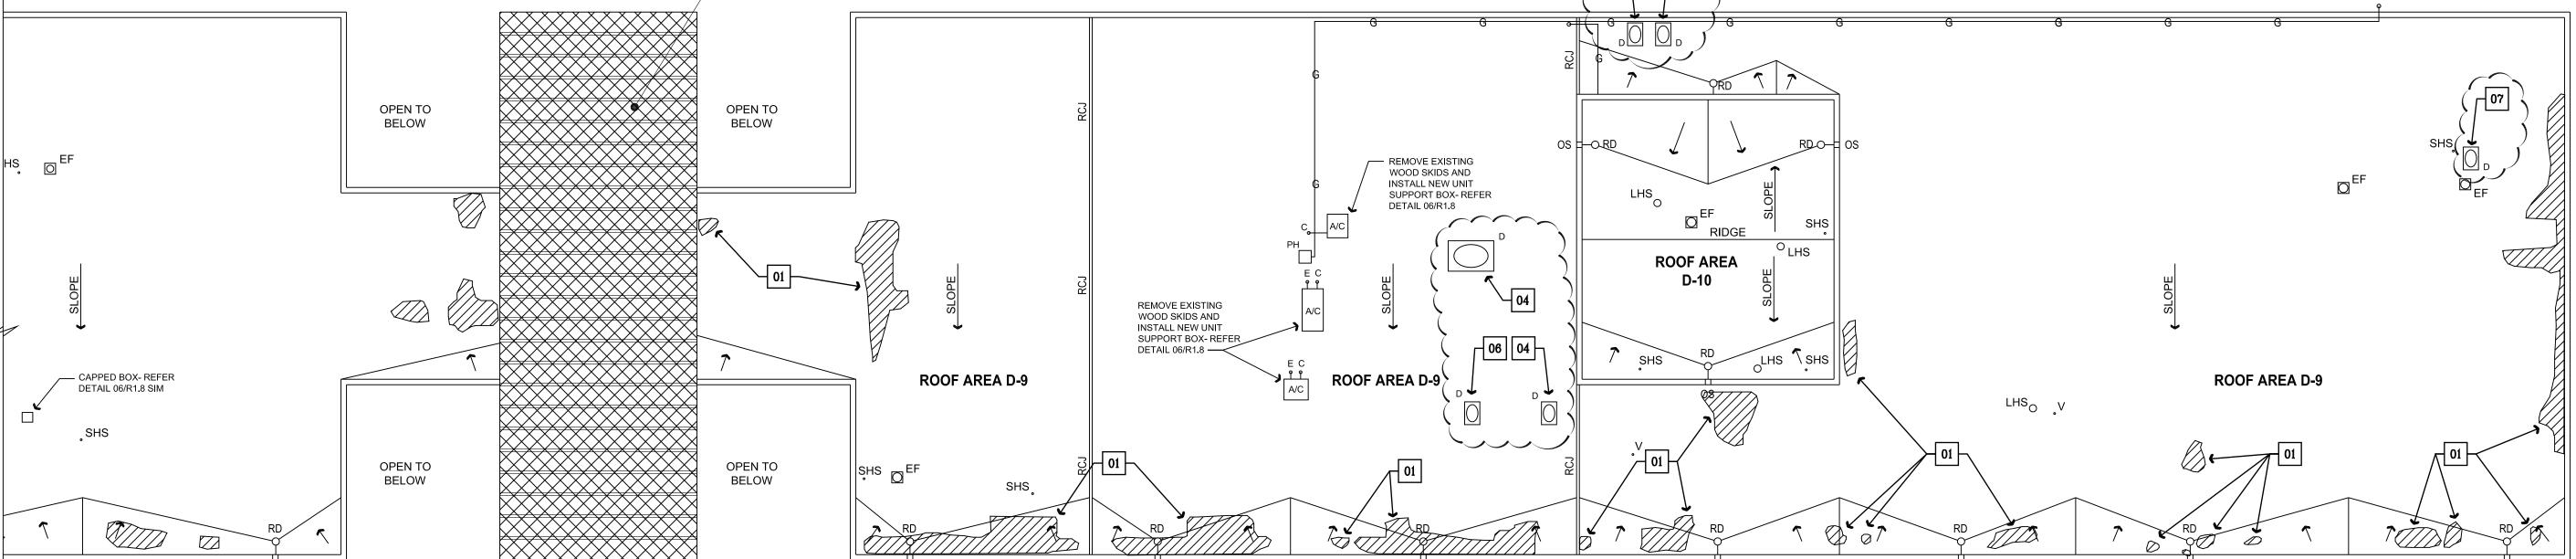
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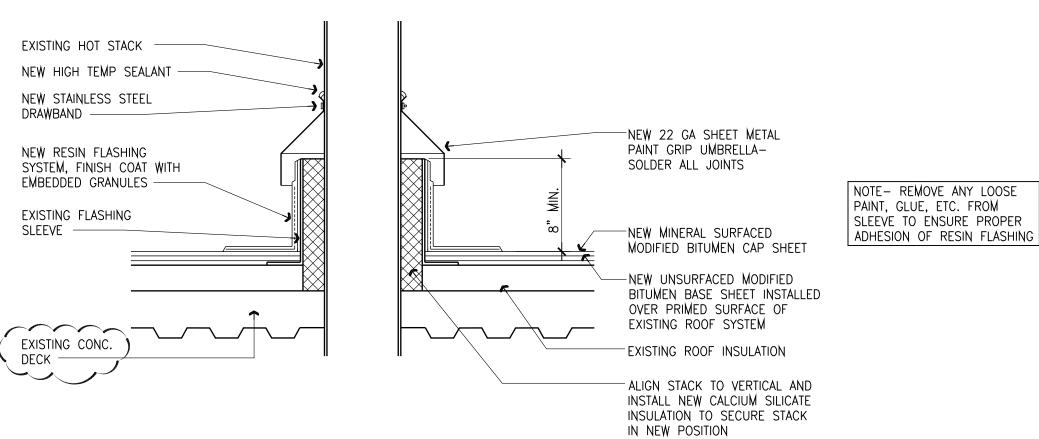
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ADDENDUM 2

Sheet Title Demo Plan-Areas D9, D10

Project Number 46-17026N AS NOTED 08/28/17





13 Large Hot Stack Detail Scale: 1-1/2" = 1'-0"

EXISTING HOT STACK

NEW STAINLESS STEEL

DRAWBAND —

GRANULES -

SLEEVE -


EXISTING FLASHING

EXISTING CONC.
DECK


NEW HIGH TEMP SEALANT

NEW RESIN FLASHING SYSTEM,


FINISH COAT WITH EMBEDDED

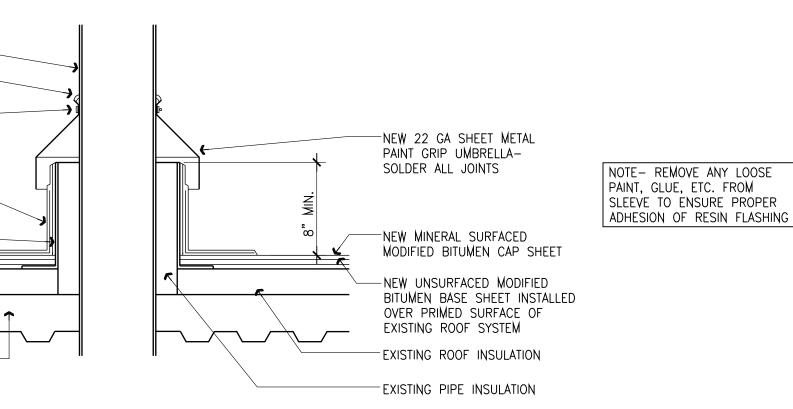

10 Small Hot Stack Detail Scale: 1-1/2" = 1'-0"

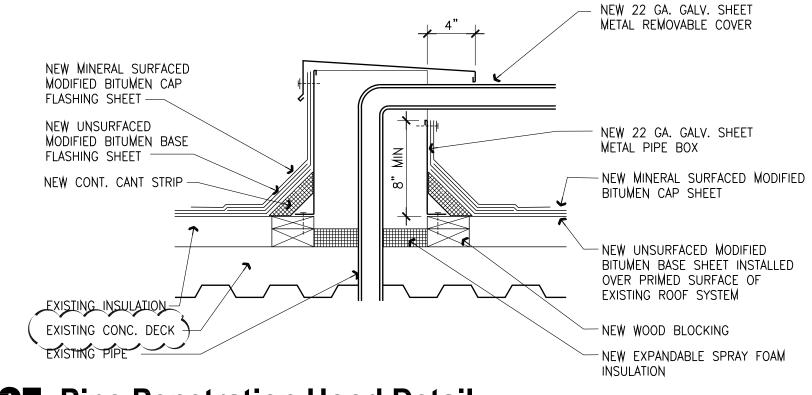


17 Pipe Penetration Hood Detail

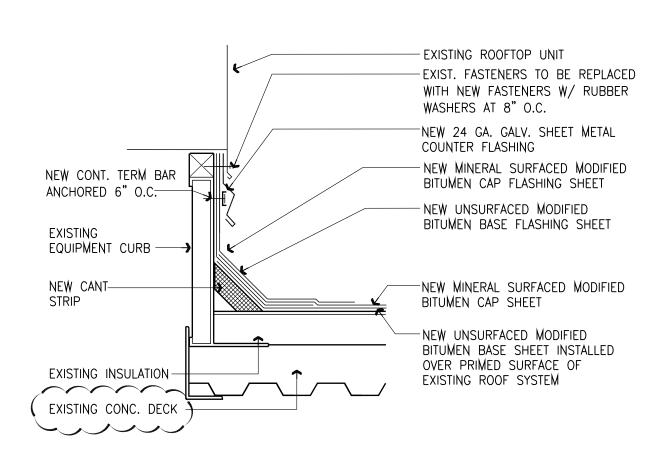

14 Equipment Curb Flashing Detail
Scale: 1-1/2" = 1'-0"

Roof Hatch Curb Flashing Detail
Scale: 1-1/2" = 1'-0"

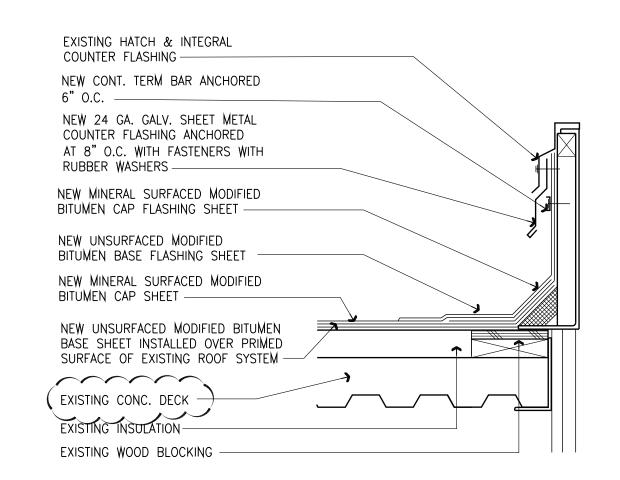

REPLACE EXIST. FASTENERS WITH NEW FASTENERS W/ RUBBER WASHERS AT 8" O.C. EXISTING SHEET METAL CAP -NEW 24 GA. GALV. SHEET METAL COUNTER FLASHING NEW CONT. TERM BAR ANCHORED 6" O.C. -- NEW MINERAL SURFACED MODIFIED BITUMEN CAP FLASHING SHEET - NEW UNSURFACED MODIFIED EXISTING BITUMEN BASE FLASHING SHEET EQUIPMENT CURB - NEW MINERAL SURFACED NEW CANT MODIFIED BITUMEN CAP SHEET NEW UNSURFACED
MODIFIED BITUMEN BASE SHEET INSTALLED OVER PRIMED SURFACE OF EXISTING ROOF SYSTEM EXISTING CONC. DECK —

12 Prefabricated Curb Detail
Scale: 1-1/2" = 1'-0"


EXISTING PIPE-

EXISTING CONC.


DECK

NEW 30" SQ. LEAD SHEET/ PRIME AND SET IN MASTIC NEW MODIFIED BITUMEN CAP FLASHING SHEET -NEW MASTIC NEW MINERAL SURFACED -NEW 36" SQUARE MODIFIED MODIFIED BITUMEN CAP BITUMEN UNSURFACED STRIP IN PLY NEW UNSURFACED MODIFIED BITUMEN BASE SHEET INSTALLED OVER PRIMED SURFACE OF EXISTING ROOF SYSTEM EXISTING INSULATION TAPERED TO DRAIN — EXISTING CONC. DECK


11 Roof Drain Flashing Detail Scale: 1-1/2" = 1'-0"

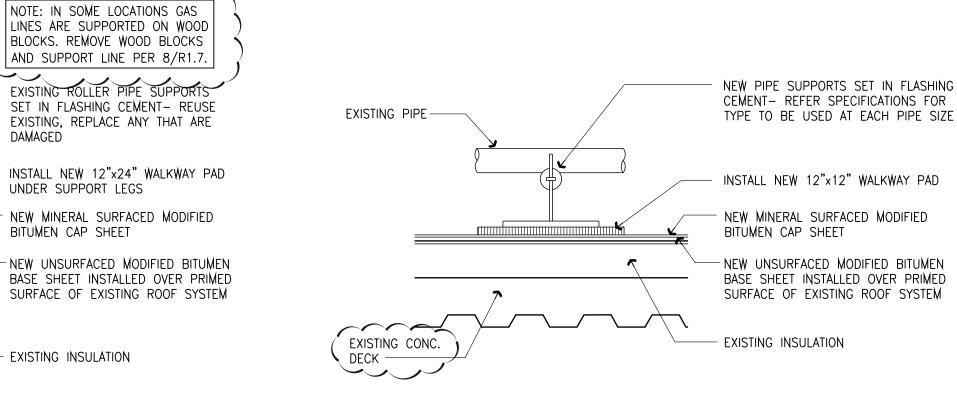

19 Pipe Roller Support Detail Scale: 1-1/2" = 1'-0"

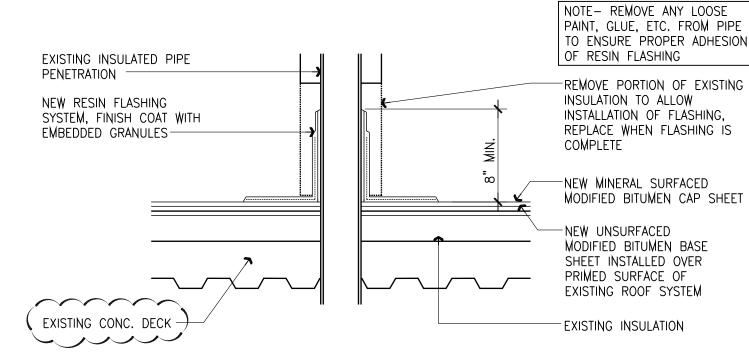


106 Insulated Pipe Flashing Detail Scale: 1-1/2" = 1'-0"

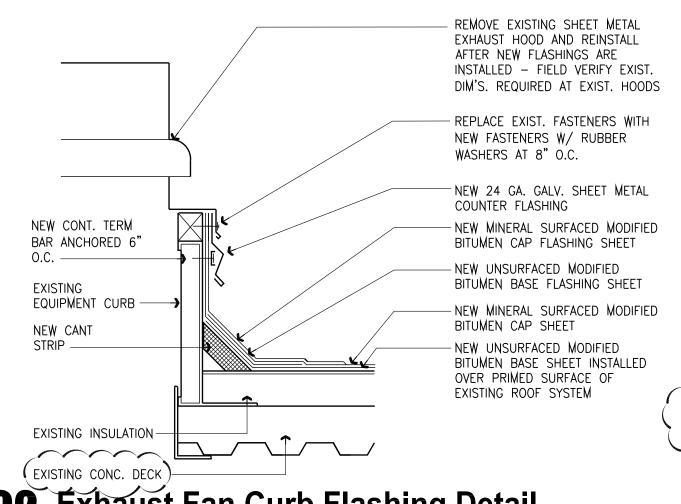


Éxhaust Fan Curb Flashing Detail

18 Pipe Molded Support Detail Scale: 1-1/2" = 1'-0"

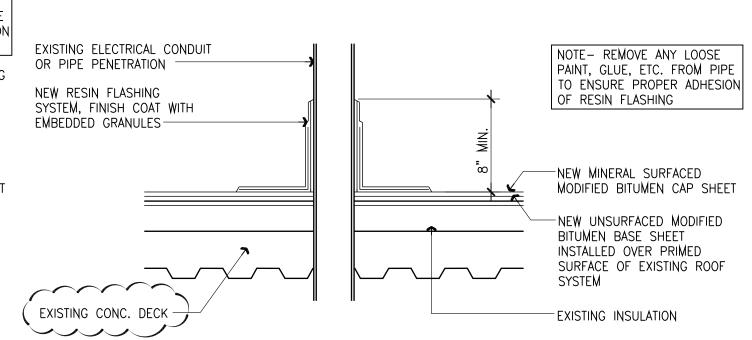

O5 Pipe Flashing Detail Scale: 1-1/2" = 1'-0"

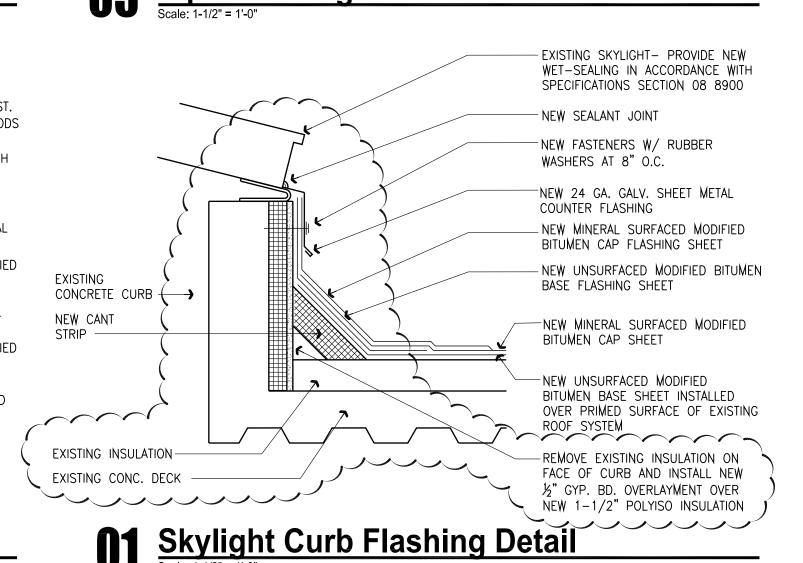

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DryTec



Recovery County Justice County Jus ollin County nney, Texas

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Sheet Title **Roof Details**


Project Number 46-17026N AS NOTED Scale: 08/28/17 Date

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3" 1"

NEW 22 GA. GALV. SHEET

FASTENERS WITH RUBBER


_NEW UNSURFACED MODIFIED

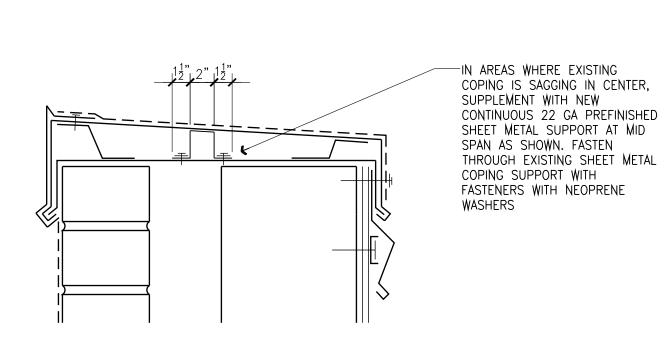
OVER PRIMED SURFACE OF

EXISTING ROOF SYSTEM

BITUMEN CAP SHEET

WASHERS

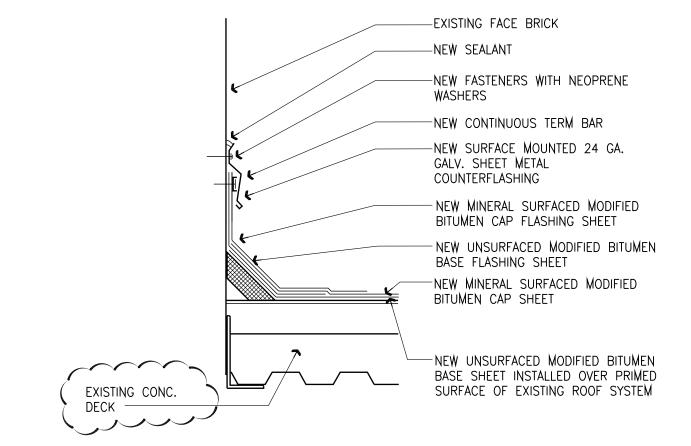

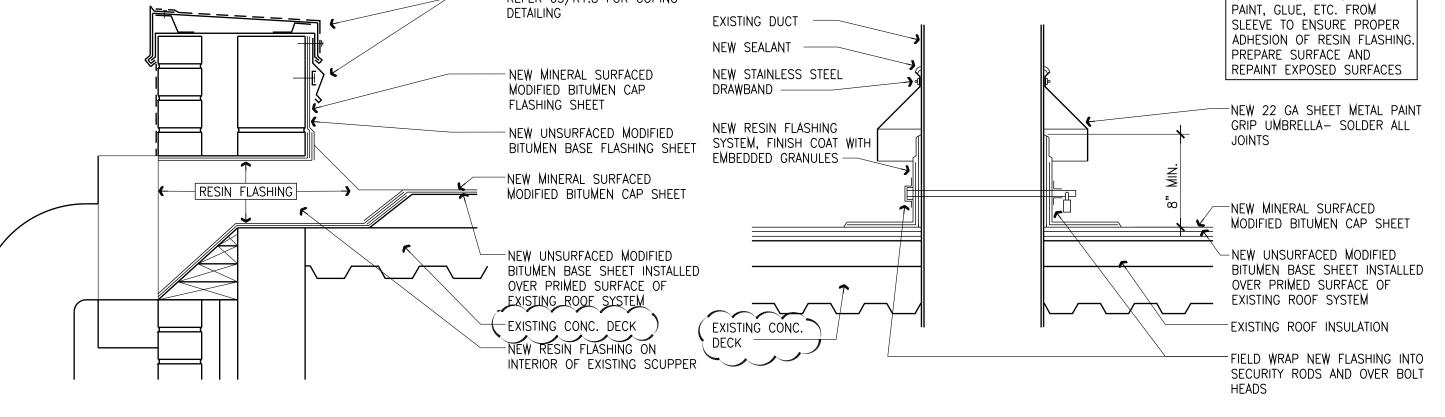

12 Coping Support Detail Scale: 3" = 1'-0"

NEW MINERAL SURFACED

MODIFIED BITUMEN CAP

FLASHING SHEET -

NEW UNSURFACED

MODIFIED BITUMEN

BASE FLASHING SHEET

NEW CONT. CANT STRIP

EXISTING INSULATION

(EXISTING CONC. DECK angle

EXISTING BARREL

CONCRETE -


VAULT METAL PANELS —

APPLY NEW ELASTOMERIC


COATING TO EXPOSED

EXISTING CONCRETE

EXISTING CONC. DECK

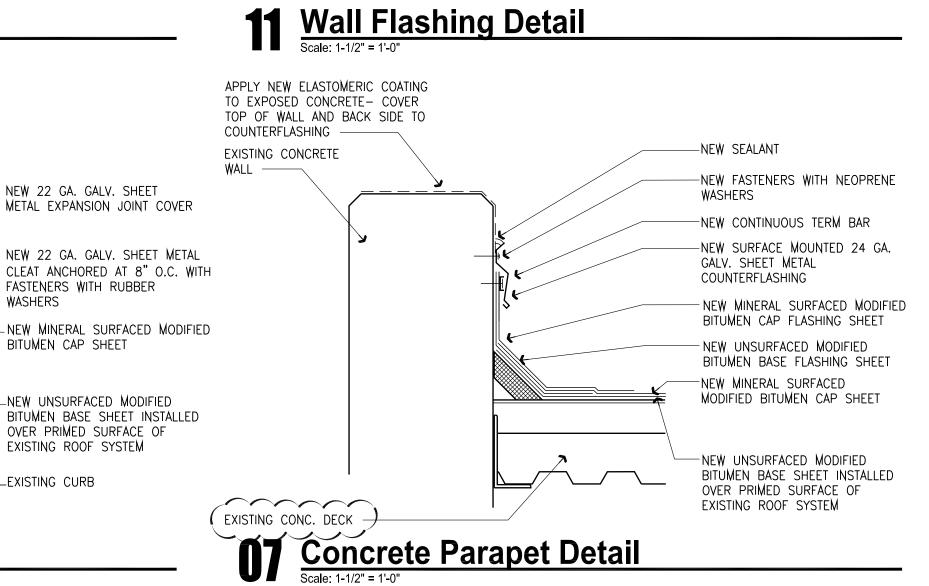



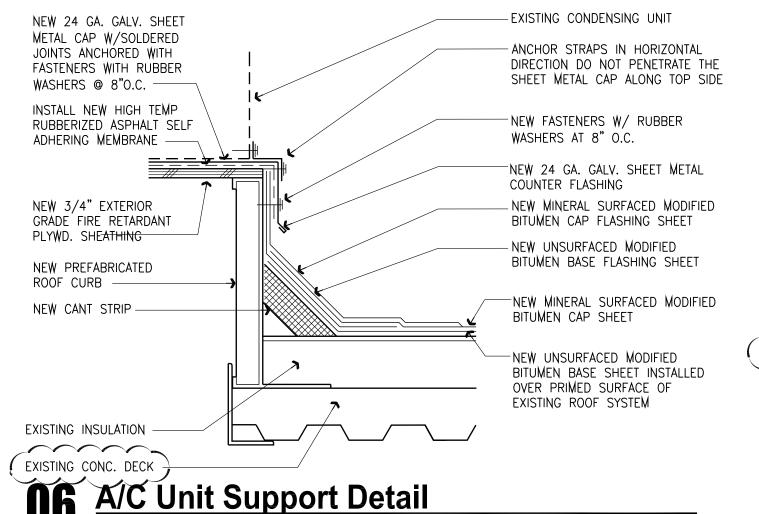

AND NEW


NEW ROOF SYSTEM

ROOFING SYSTEM


— EXISTING INSULATION

- EXISTING CONC. DECK

19 Duct Penetration Detail
Scale: 1-1/2" = 1'-0"

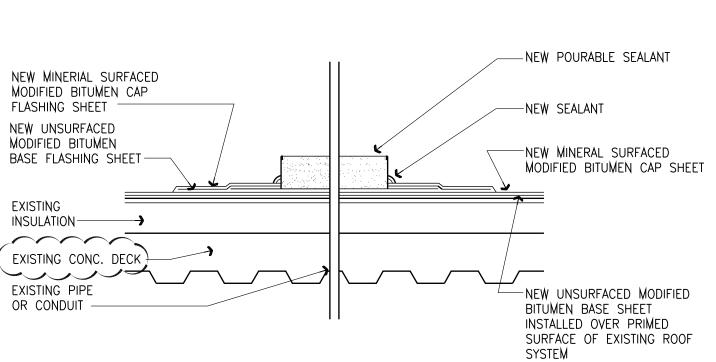

O6 Expansion Joint Detail
Scale: 1-1/2" = 1'-0"

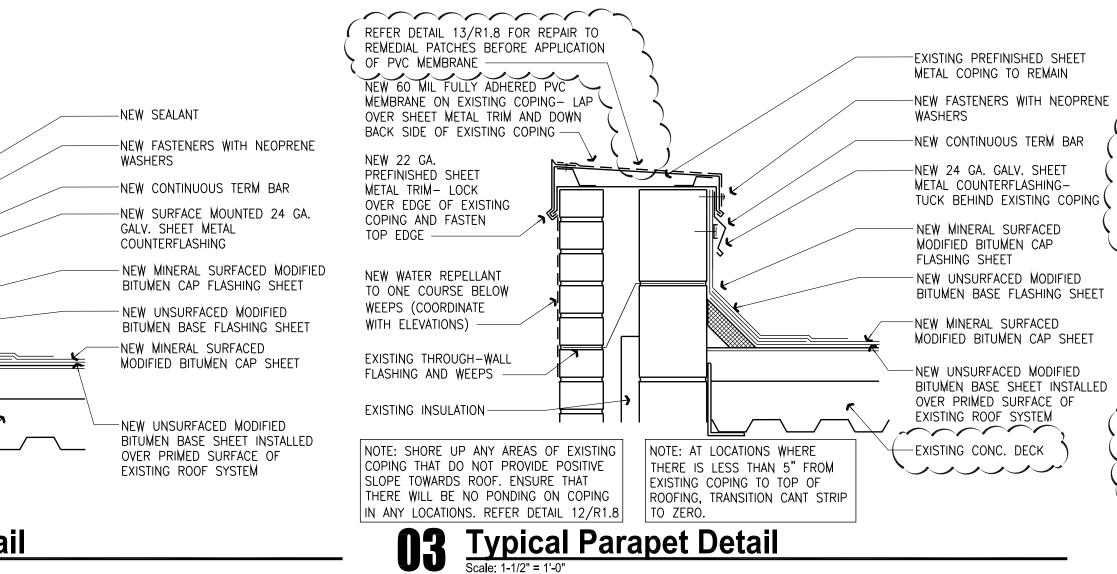

06 A/C Unit Support Detail

NEW LAYER UNSURFACED

MODIFIED BITUMEN BASE SHEET

INSTALLED OVER ROOF BOARD

(TOP OF SHEET TO ALIGN WITH

NEW ½" GYPSUM ROOF BOARD


NEW TAPERED INSULATION TO

CREATE POSITIVE SLOPE TO DRAIN

OVERLAYMENT

TOP OF EXISTING ROOFING)



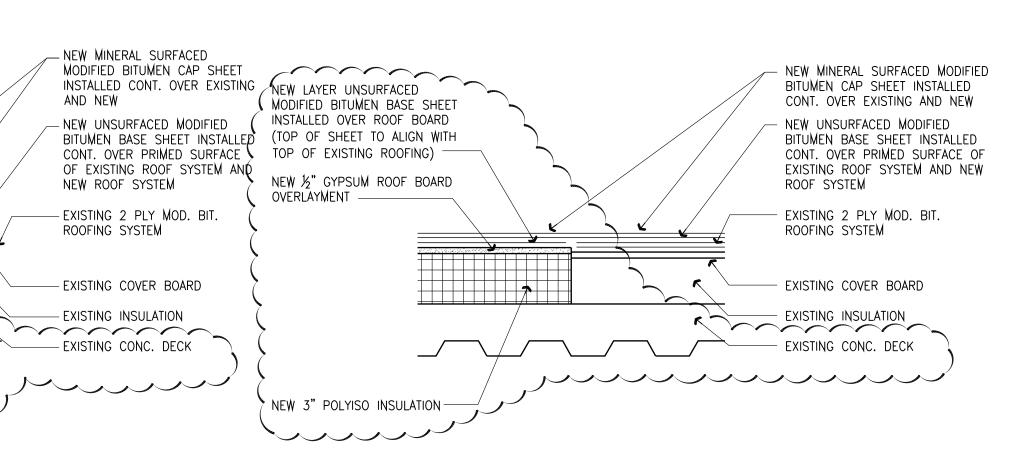

Supplemental Insulation Detail

Existing Roofing Infill Detail

County Just County Inney, Texas oof Ollin


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Sheet Title **Roof Details**

| | Project Number | 46-17026N |
|---|----------------|-----------|
| · | Scale: | AS NOTED |
| | Date | 08/28/17 |

16 of 21 Sheets

Mall Flashing DetailScale: 1-1/2" = 1'-0"

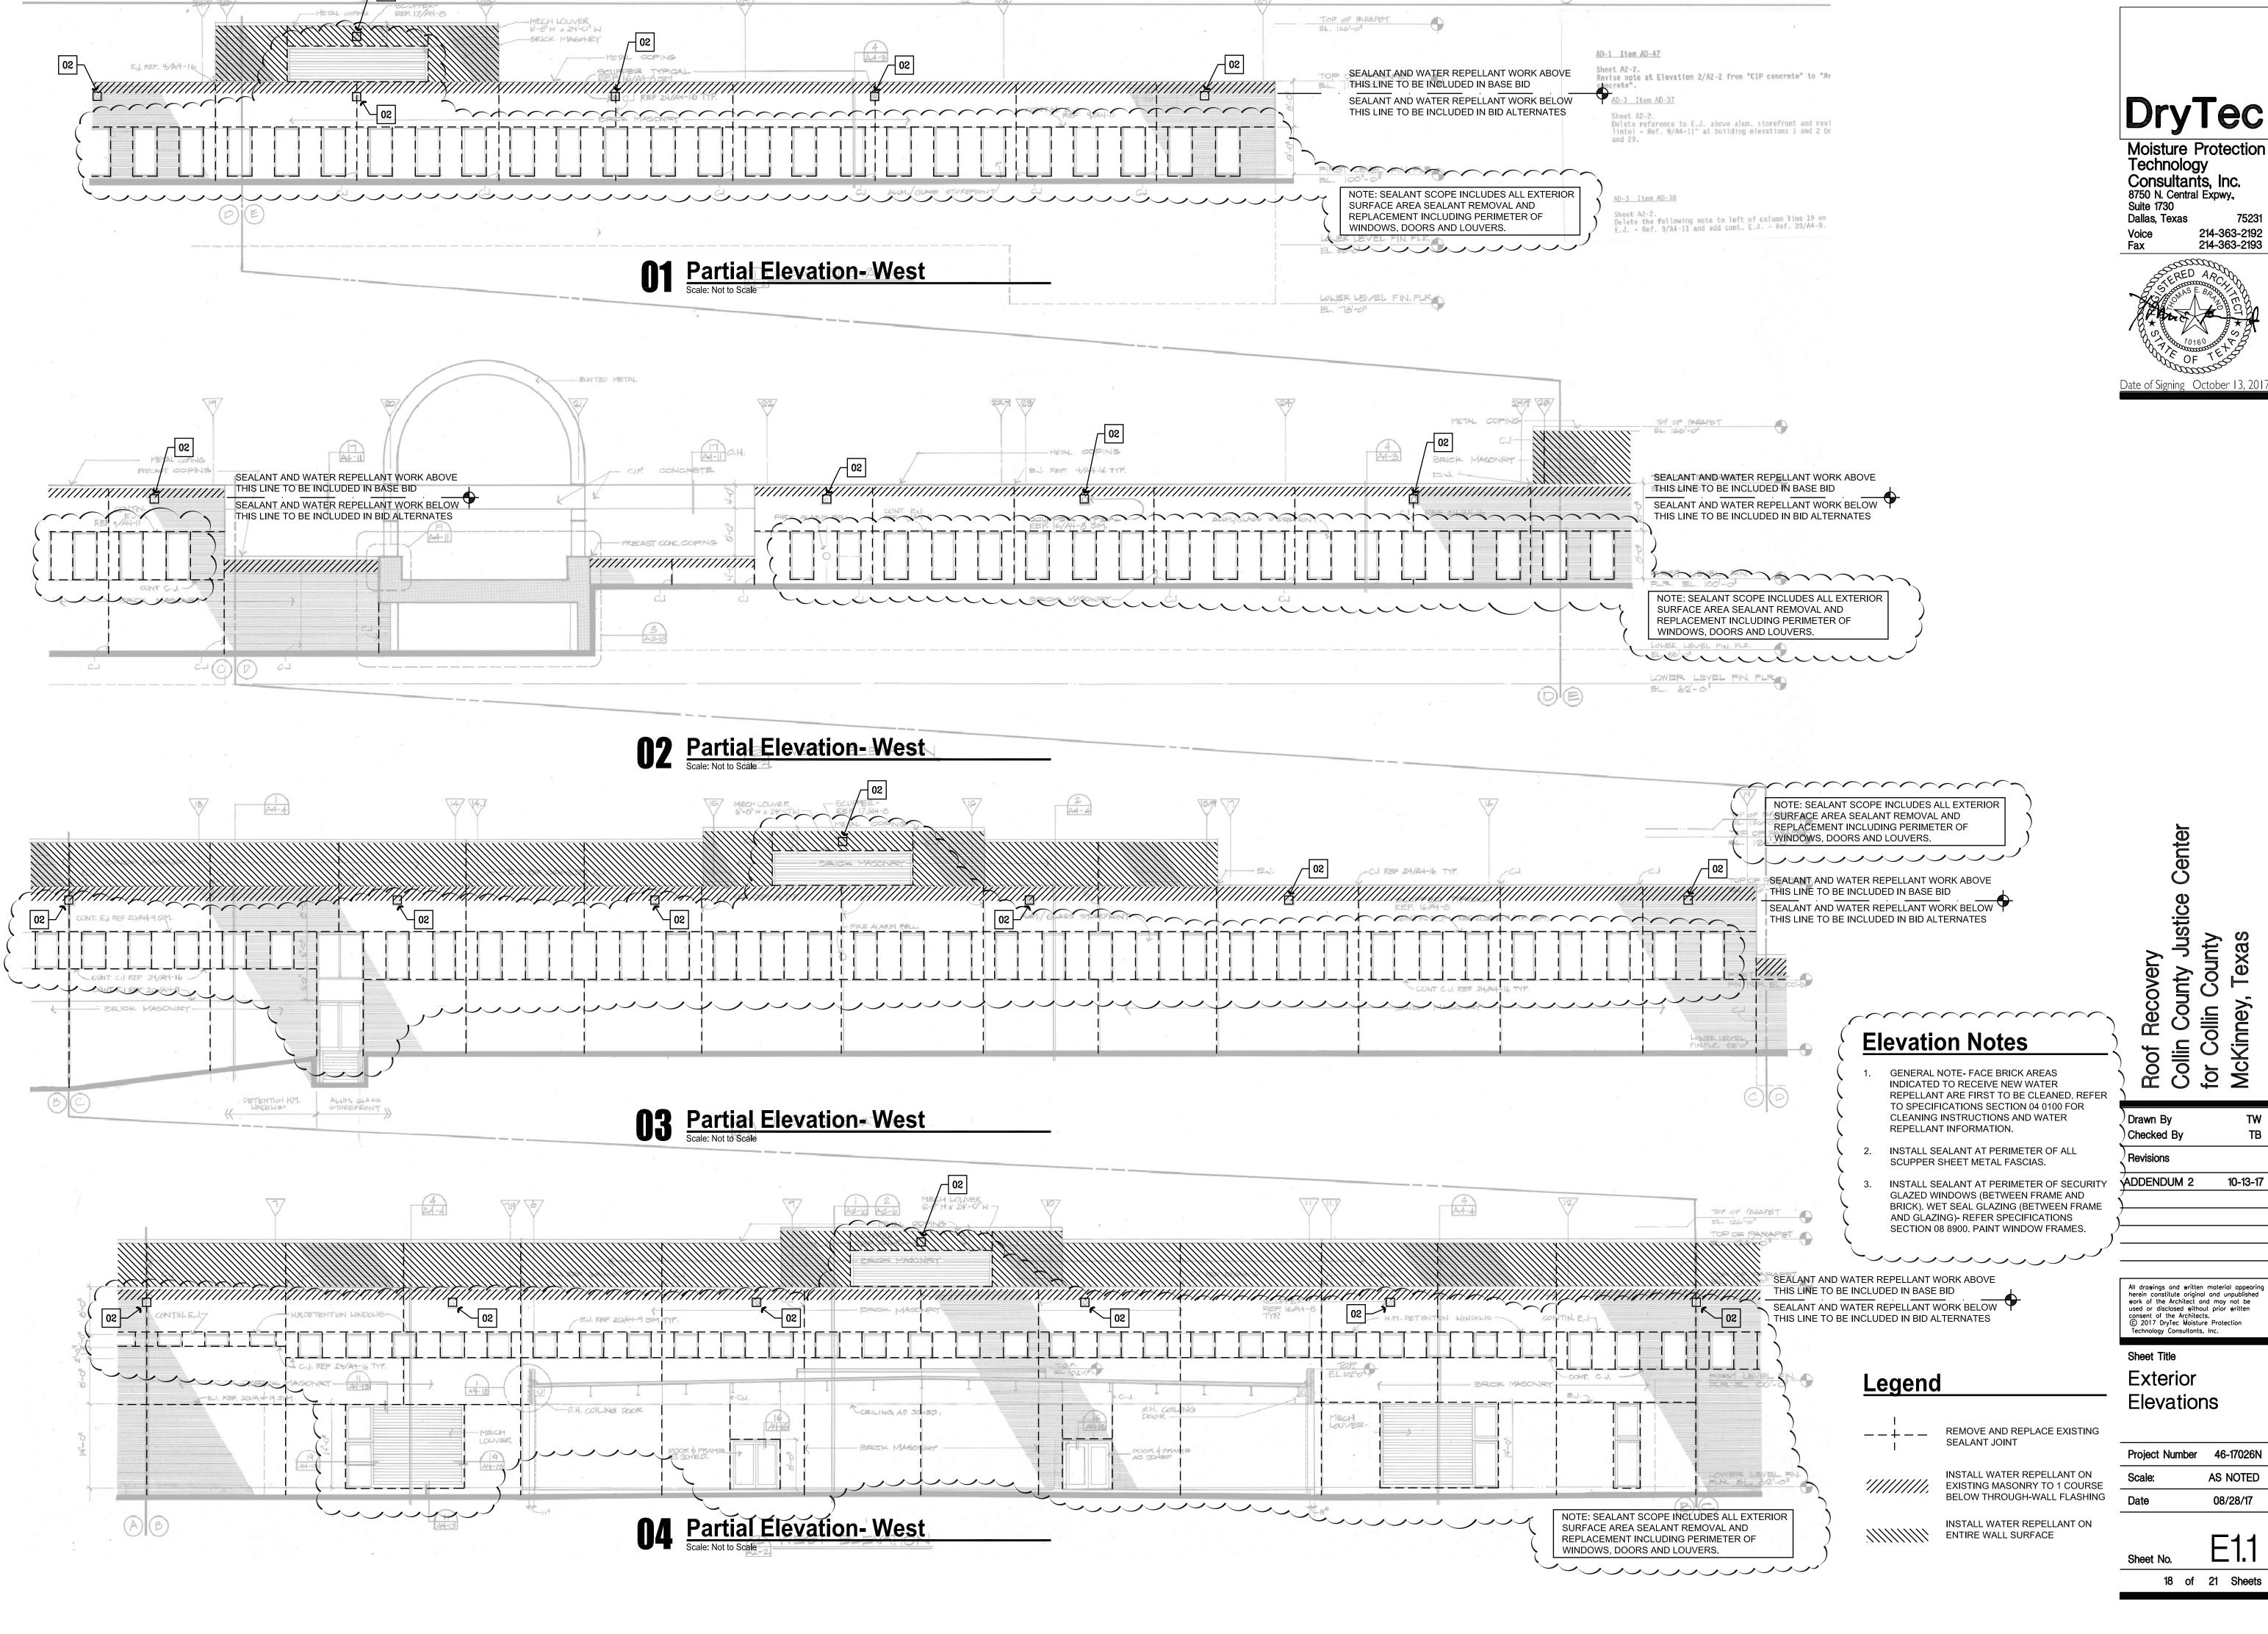

214-363-2192 214-363-2193





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All drawings and written material appearing


Project Number 46-17026N


AS NOTED 08/28/17



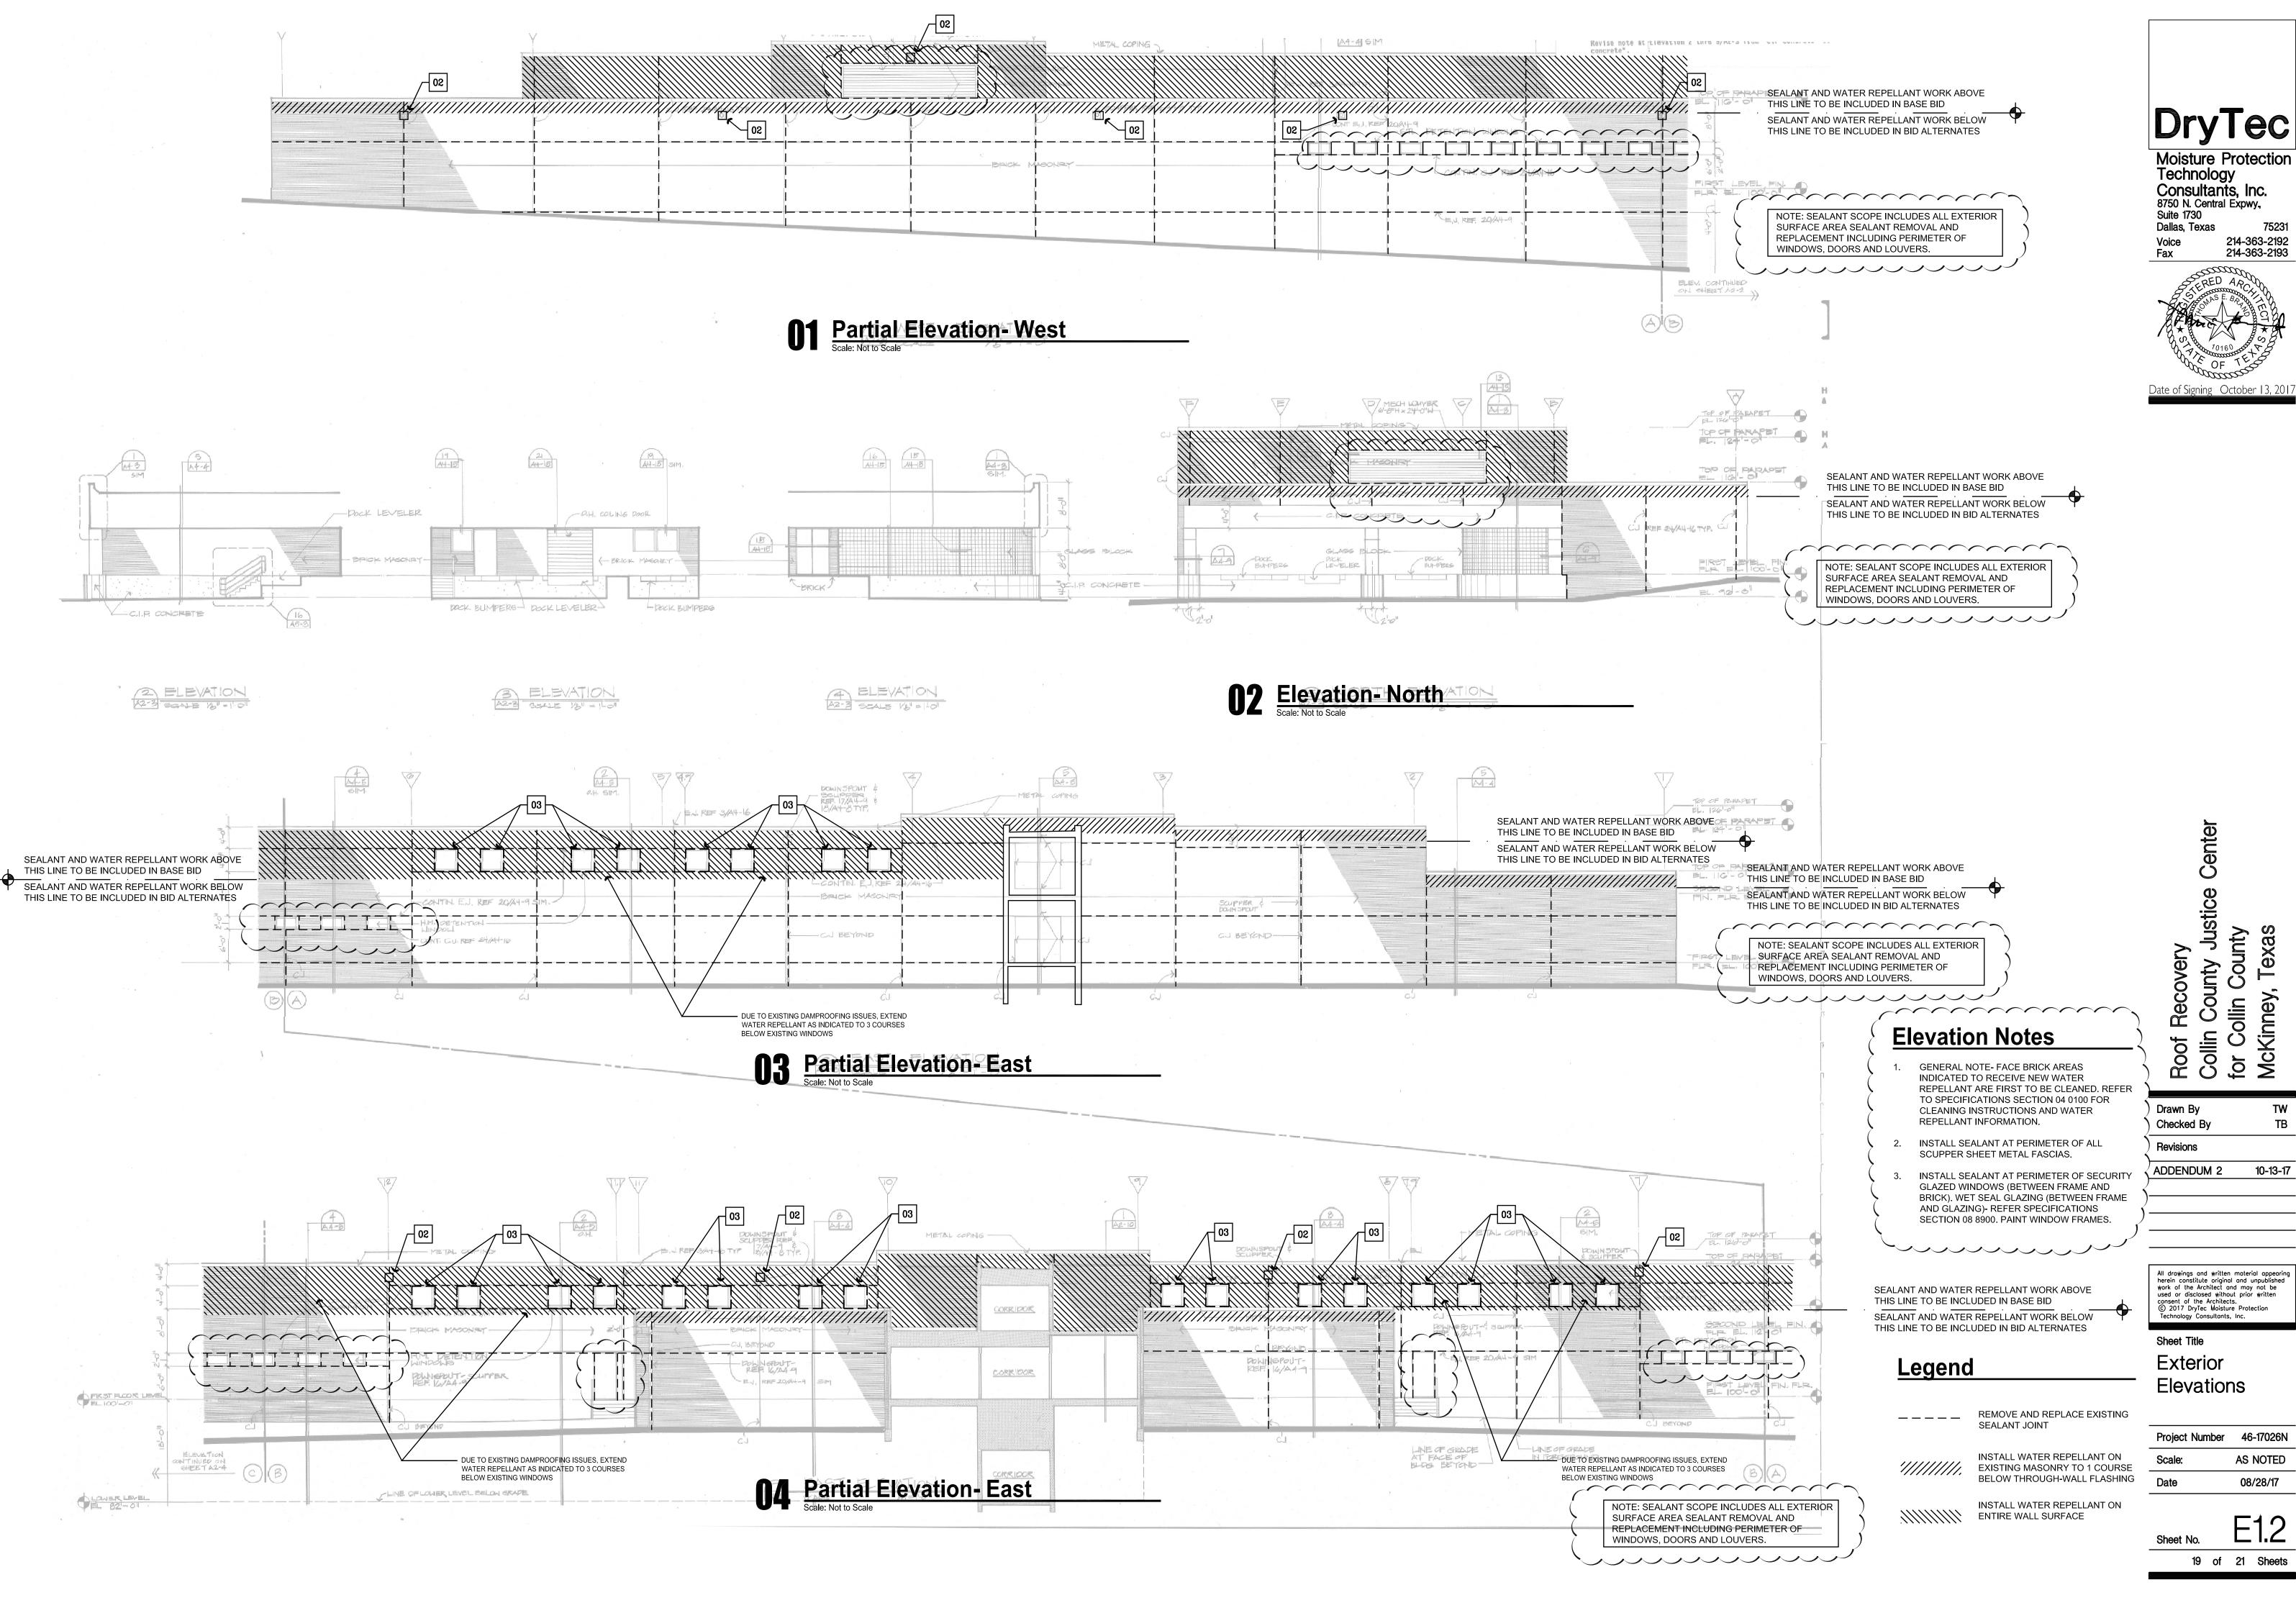


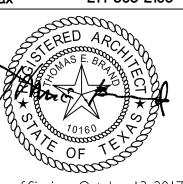08/28/17

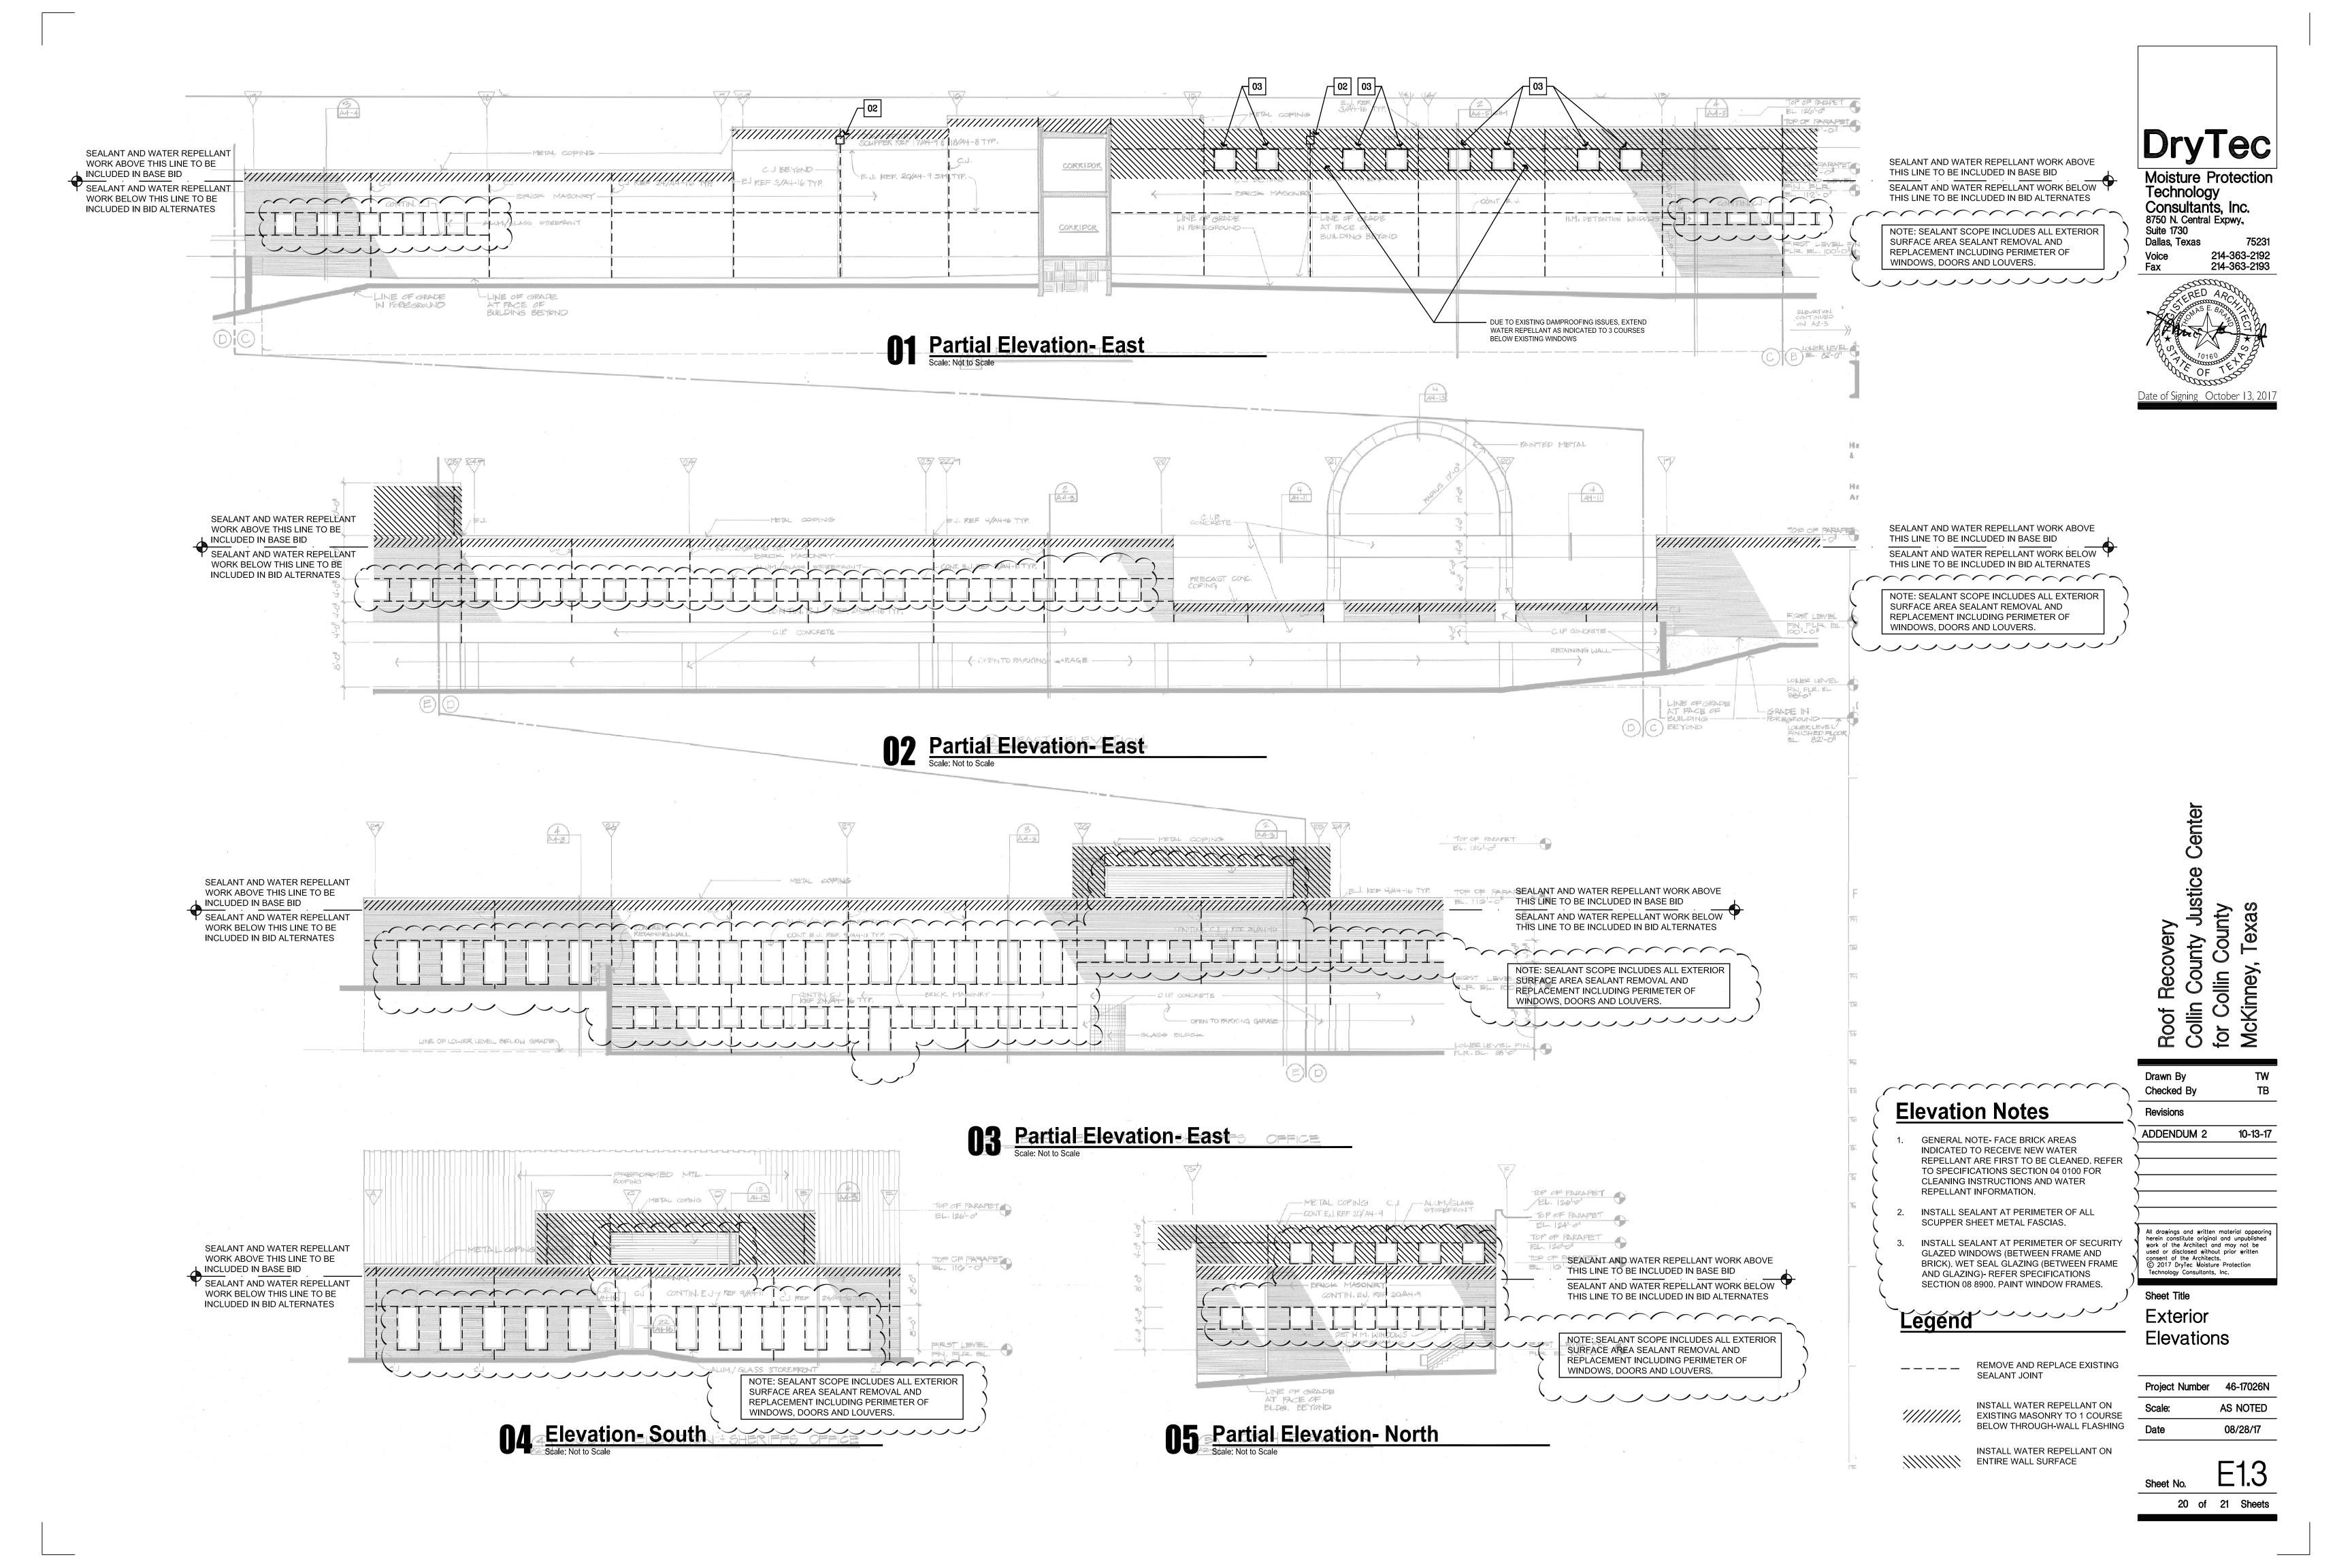


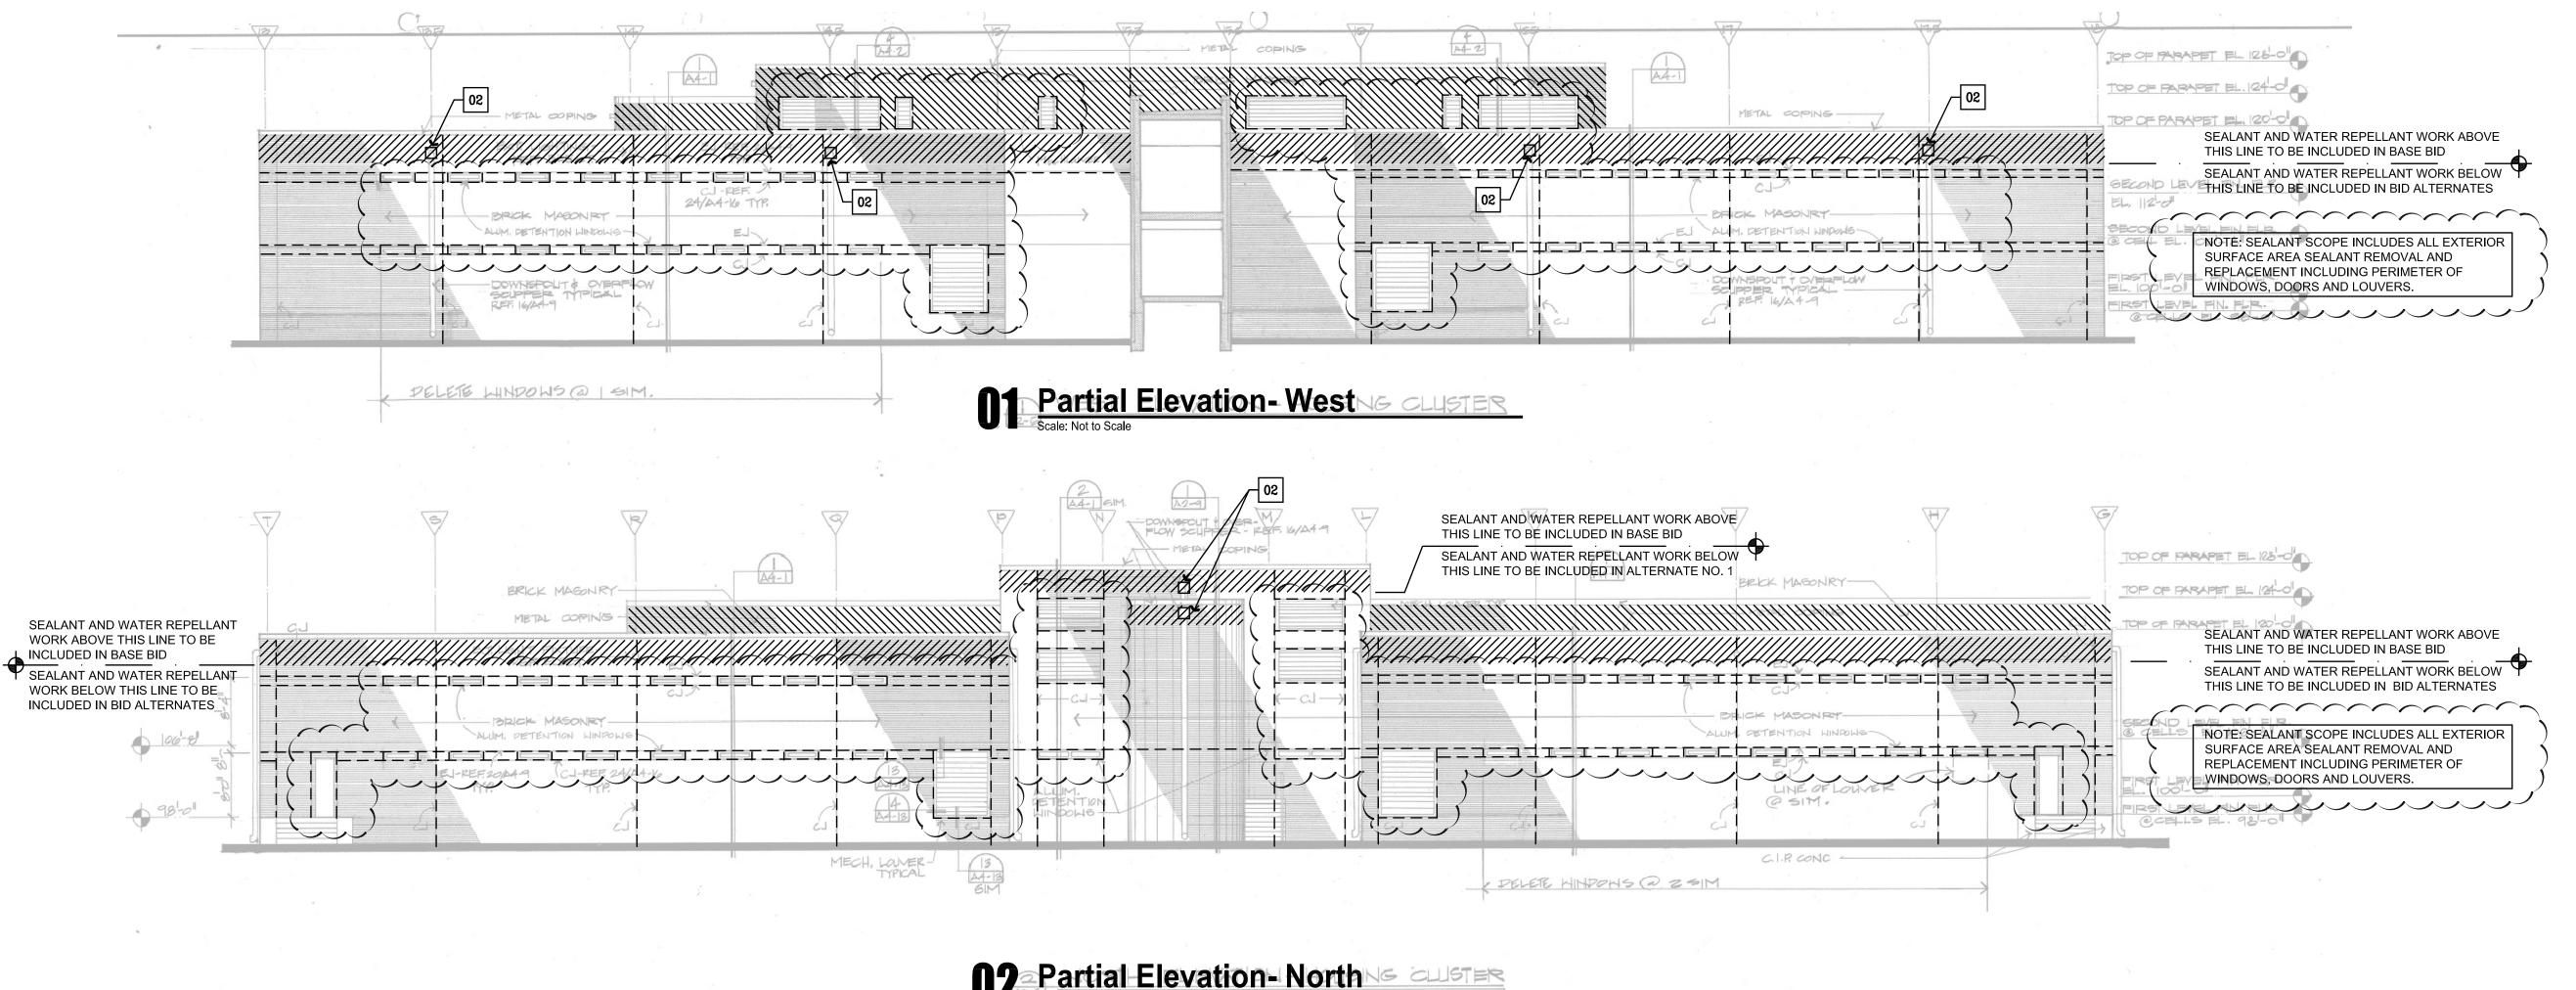

12 Partial Elevation - North Scale Not to Scale

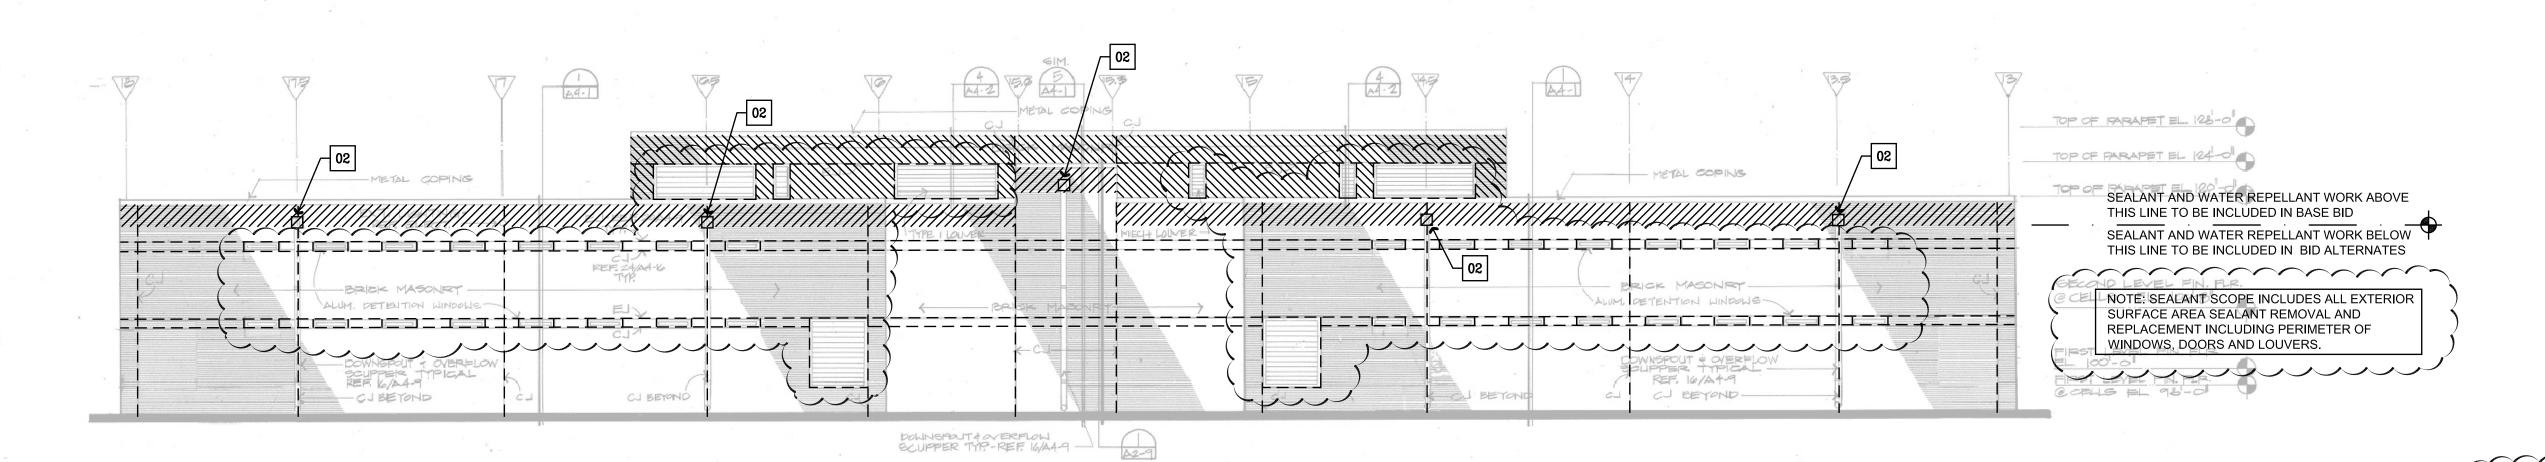

93 Partial Elevation - East

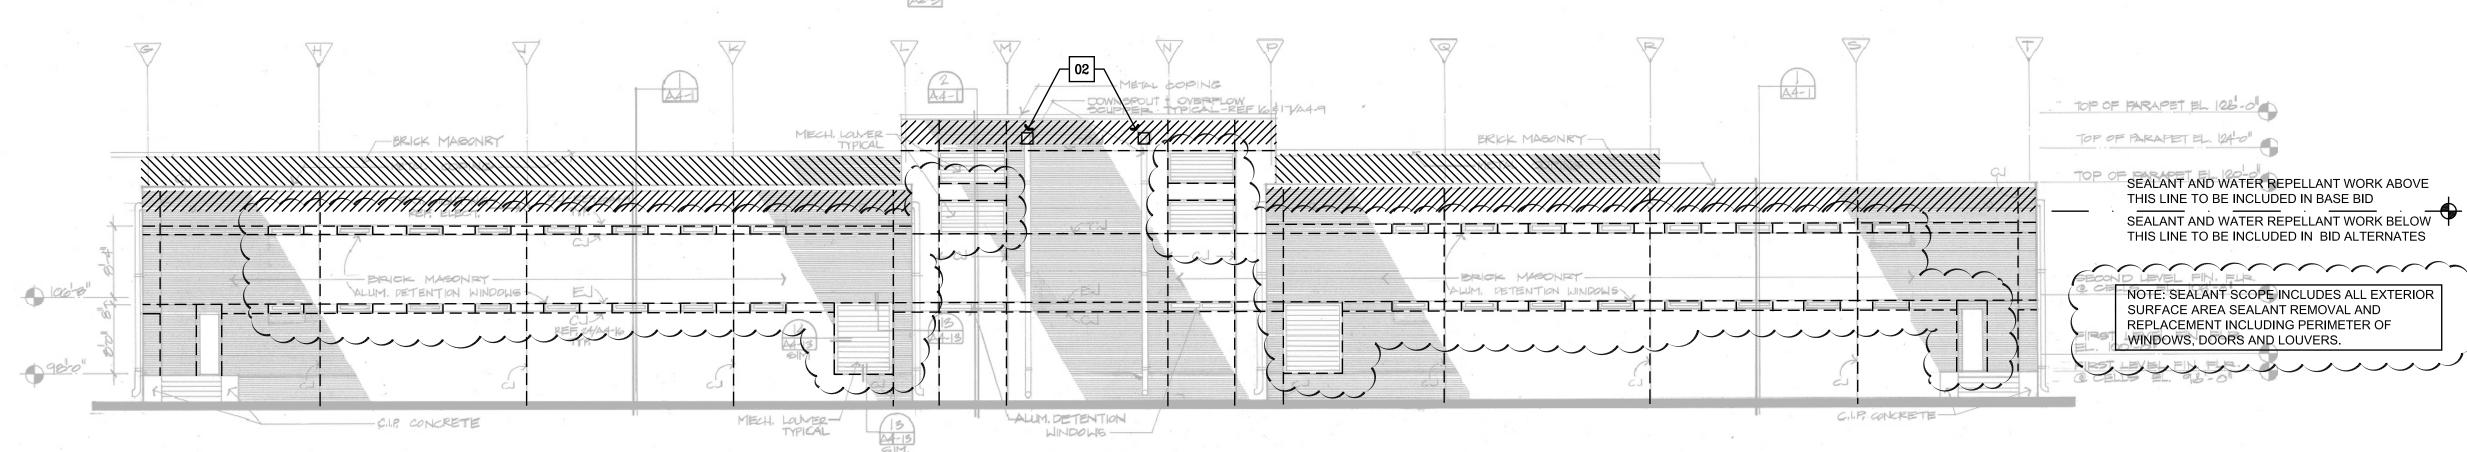

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Checked By **Elevation Notes** Revisions

GENERAL NOTE- FACE BRICK AREAS INDICATED TO RECEIVE NEW WATER REPELLANT ARE FIRST TO BE CLEANED. REFER TO SPECIFICATIONS SECTION 04 0100 FOR CLEANING INSTRUCTIONS AND WATER REPELLANT INFORMATION.

- INSTALL SEALANT AT PERIMETER OF ALL SCUPPER SHEET METAL FASCIAS.
- GLAZED WINDOWS (BETWEEN FRAME AND BRICK). WET SEAL GLAZING (BETWEEN FRAME AND GLAZING)- REFER SPECIFICATIONS

Legend

REMOVE AND REPLACE EXISTING SEALANT JOINT

INSTALL WATER REPELLANT ON EXISTING MASONRY TO 1 COURSE BELOW THROUGH-WALL FLASHING

> INSTALL WATER REPELLANT ON ENTIRE WALL SURFACE

Elevations Project Number 46-17026N

ADDENDUM 2 10-13-17

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Sheet Title

Exterior

AS NOTED Scale: 08/28/17

Partial Elevation- South