

- REFER DEMOLITION PLANS FOR REPLACEMENT OF EXISTING MOISTURE DAMAGED INSULATION AND PREPARATION OF EXISTING ROOFING TO RECEIVE
- CUT 6" LONG SLITS THROUGH CAP SHEET AND BASE PLY AT 3 FOOT ON CENTER BOTH WAYS IN ENTIRE ROOF RECOVERY AREA.
- PROVIDE NEW WET-SEALING OF ALL EXISTING EXTERIOR SKYLIGHTS IN ACCORDANCE WITH SPECIFICATIONS SECTION 08 8900.

NEW ROOF RECOVERY SYSTEM

ALL ROOF AREAS (EXCEPT AS NOTED BELOW):

- MINERAL SURFACED SBS MODIFIED BITUMEN ROOF MEMBRANE TORCH APPLIED OVER UNSURFACED BASE PLY TORCH APPLIED OVER PRIMED SURFACE OF EXISTING MODIFIED BITUMEN CAP SHEET AFTER ALL WET MATERIALS HAVE BEEN REMOVED AND REPLACED AND AFTER 6" SLITS ARE CUT INTO THE EXISTING ROOF SYSTEM THROUGH THE ROOFING MEMBRANE.
- NOTE THAT ALL EXISTING BASE FLASHINGS ARE TO BE REMOVED AND REPLACED. - INSTALL NEW BASE FLASHINGS IN ALL LOCATIONS PER DETAILS.
- REMOVE ALL SHEET METAL COUNTER FLASHINGS.
- INSTALL NEW MEMBRANE AND COUNTER FLASHING AT ALL COPINGS PER DETAILS. - REMOVE ALL SHEET METAL "CONES" FROM EXISTING ROOF PENETRATATIONS.

NOTICE TO OWNER PRIOR TO REMOVING AND RAISING CONDUITS AND PIPING.

- ROOFTOP HVAC UNITS: RAISE CURB HEIGHTS AS REQUIRED TO PROVIDE MINIMUM 8" FLASHING HEIGHT. WORK TO INCLUDE DISCONNECT OF EXISTING ELECTRICAL CONNECTIONS, GAS PIPING AND CONDENSATE LINES. EXTEND AND RECONNECT ELECTRICAL, GAS AND CONDENSATE
- CONNECTIONS. PROVIDE 48 HOUR NOTICE TO OWNER PRIOR TO TAKING ANY UNIT OUT OF SERVICE. - GAS PIPING, ELECTRICAL CONDUITS AND CONDENSATE DRAIN PIPING: RAISE SUCH PIPING TO ACCOMMODATE THE INSTALLATION OF NEW ROOF SYSTEM. RECONNECT SUCH PIPING AS REQUIRED TO PROVIDE FUNCTIONING SYSTEM. INSTALL PIPE SUPPORTS AS SPECIFIED. PROVIDE 48 HOUR

NEW ROOFING SYSTEM


ROOF AREAS A7, A8, B9, B10, C7 AND C8:

- MINERAL SURFACED SBS MODIFIED BITUMEN ROOF MEMBRANE TORCH APPLIED OVER UNSURFACED BASE PLY TORCH APPLIED OVER 1/2" GYPSUM SHEATHING ADHERED TO ¾" MINIMUM THICKNESS ¼" PER FOOT TAPERED POLYISOCYANURATE INSULATION ADHERED TO 2" THICK POLYISOCYANURATE INSULATION MECHANICALLY FASTENED TO EXISTING DECK. FORM CRICKETS WITH ½" PER FOOT TAPERED POLYISOCYANURATE INSULATION.

• REFER SPECIFICATIONS FOR PRICING ALTERNATE REGARDING CLEANING, PRIMING AND PAINTING OF GAS PIPING, HOT STACKS AND EMERGENCY ENGINE


- ALL SIGHT EXPOSED ROOFING RELATED SHEET METAL VISIBLE FROM GROUND LEVEL TO BE FORMED OUT OF PRE-FINSHED SHEET METAL.
- ALL NON SIGHT EXPOSED ROOFING RELATED SHEET METAL NOT VISIBLE FROM GROUND LEVEL TO BE FORMED OUT OF GALVANIZED SHEET METAL. PROVIDE WALK PADS AT THE BASE AND THE TOP OF ALL ROOF ACCESS LADDERS AND THREE SIDES OF ROOF HATCH.
- INSTALL INSULATION CRICKETS ON THE HIGH SIDE OF ALL ROOF CURBS.
- ALL GAS, CONDENSATE AND ELECTRICAL CONDUIT LINES TO BE SUPPORTED PER DETAILS.
- REPLACE MISSING SPLASH BLOCKS AT OUTLET OF ANY DOWNSPOUTS THAT DRAIN ONTO ROOF AREAS.

Legend

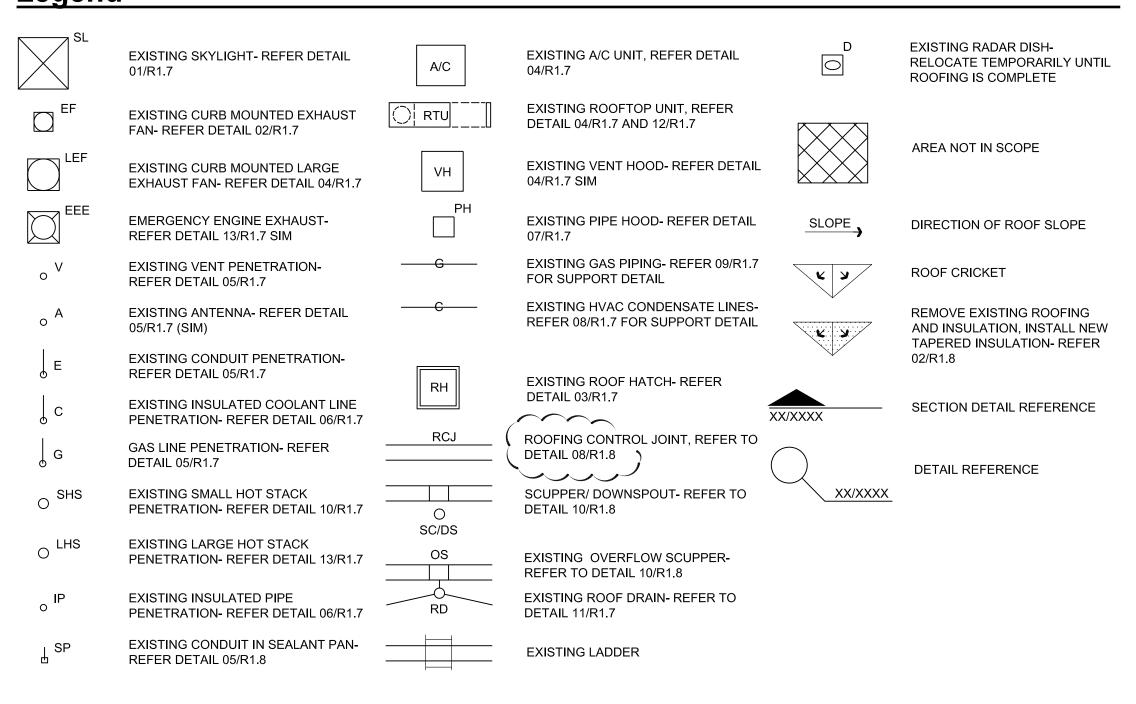





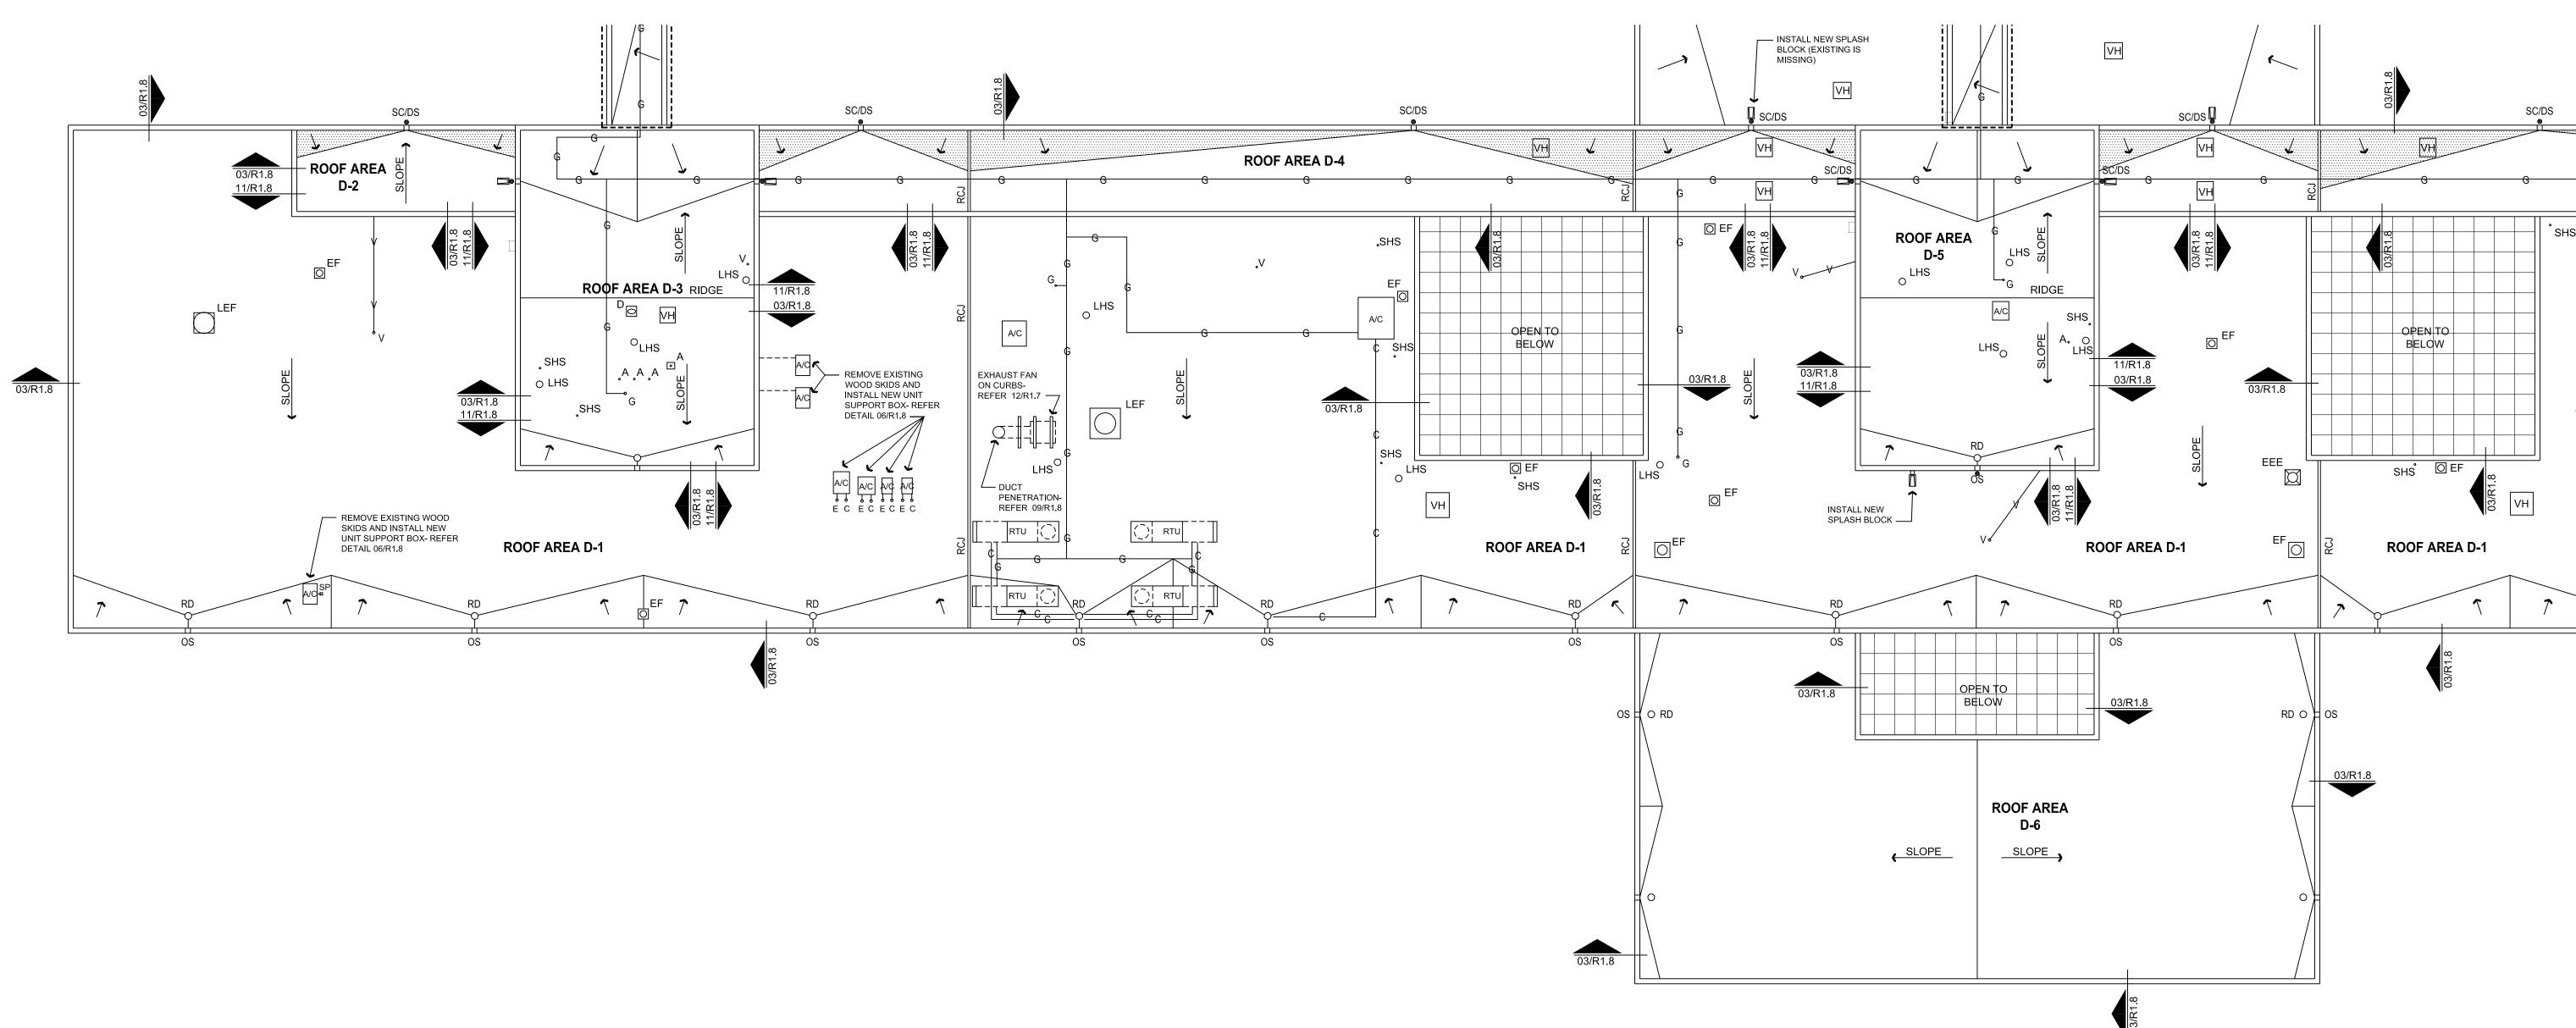

Checked By ADDENDUM 3 10-19-17

All drawings and written material appearing herein constitute original and unpublishe work of the Architect and may not be used or disclosed without prior written consent of the Architects.
© 2017 DryTec Moisture Protection Technology Consultants, Inc.

Sheet Title Roof Plan-Areas D1-D6

Project Number 46-17026N AS NOTED 08/28/17

New Construction General Notes

- REFER DEMOLITION PLANS FOR REPLACEMENT OF EXISTING MOISTURE DAMAGED INSULATION AND PREPARATION OF EXISTING ROOFING TO RECEIVE NEW ROOFING.
- CUT 6" LONG SLITS THROUGH CAP SHEET AND BASE PLY AT 3 FOOT ON CENTER BOTH WAYS IN ENTIRE ROOF RECOVERY AREA. SECURE ALL LOOSE EXISTING VENT HOODS.
- PROVIDE NEW WET-SEALING OF ALL EXISTING EXTERIOR SKYLIGHTS IN ACCORDANCE WITH SPECIFICATIONS SECTION 08 8900.

NEW ROOF RECOVERY SYSTEM

ALL ROOF AREAS (EXCEPT AS NOTED BELOW):


- MINERAL SURFACED SBS MODIFIED BITUMEN ROOF MEMBRANE TORCH APPLIED OVER UNSURFACED BASE PLY TORCH APPLIED OVER PRIMED SURFACE OF EXISTING MODIFIED BITUMEN CAP SHEET AFTER ALL WET MATERIALS HAVE BEEN REMOVED AND REPLACED AND AFTER 6" SLITS ARE CUT INTO THE EXISTING ROOF SYSTEM THROUGH THE ROOFING MEMBRANE.
- NOTE THAT ALL EXISTING BASE FLASHINGS ARE TO BE REMOVED AND REPLACED.
- INSTALL NEW BASE FLASHINGS IN ALL LOCATIONS PER DETAILS.
- REMOVE ALL SHEET METAL COUNTER FLASHINGS. - INSTALL NEW MEMBRANE AND COUNTER FLASHING AT ALL COPINGS PER DETAILS.
- REMOVE ALL SHEET METAL "CONES" FROM EXISTING ROOF PENETRATATIONS. - ROOFTOP HVAC UNITS: RAISE CURB HEIGHTS AS REQUIRED TO PROVIDE MINIMUM 8" FLASHING HEIGHT. WORK TO INCLUDE DISCONNECT OF
- EXISTING ELECTRICAL CONNECTIONS, GAS PIPING AND CONDENSATE LINES. EXTEND AND RECONNECT ELECTRICAL, GAS AND CONDENSATE CONNECTIONS. PROVIDE 48 HOUR NOTICE TO OWNER PRIOR TO TAKING ANY UNIT OUT OF SERVICE.
- GAS PIPING, ELECTRICAL CONDUITS AND CONDENSATE DRAIN PIPING: RAISE SUCH PIPING TO ACCOMMODATE THE INSTALLATION OF NEW ROOF SYSTEM. RECONNECT SUCH PIPING AS REQUIRED TO PROVIDE FUNCTIONING SYSTEM. INSTALL PIPE SUPPORTS AS SPECIFIED. PROVIDE 48 HOUR NOTICE TO OWNER PRIOR TO REMOVING AND RAISING CONDUITS AND PIPING.

NEW ROOFING SYSTEM


ROOF AREAS A7, A8, B9, B10, C7 AND C8:

- MINERAL SURFACED SBS MODIFIED BITUMEN ROOF MEMBRANE TORCH APPLIED OVER UNSURFACED BASE PLY TORCH APPLIED OVER 1/2" GYPSUM SHEATHING ADHERED TO ¾" MINIMUM THICKNESS ¼" PER FOOT TAPERED POLYISOCYANURATE INSULATION ADHERED TO 2" THICK POLYISOCYANURATE INSULATION MECHANICALLY FASTENED TO EXISTING DECK. FORM CRICKETS WITH ½" PER FOOT TAPERED POLYISOCYANURATE INSULATION.
- ALL SIGHT EXPOSED ROOFING RELATED SHEET METAL VISIBLE FROM GROUND LEVEL TO BE FORMED OUT OF PRE-FINSHED SHEET METAL.
- ALL NON SIGHT EXPOSED ROOFING RELATED SHEET METAL NOT VISIBLE FROM GROUND LEVEL TO BE FORMED OUT OF GALVANIZED SHEET METAL. PROVIDE WALK PADS AT THE BASE AND THE TOP OF ALL ROOF ACCESS LADDERS AND THREE SIDES OF ROOF HATCH.
- INSTALL INSULATION CRICKETS ON THE HIGH SIDE OF ALL ROOF CURBS. • REFER SPECIFICATIONS FOR PRICING ALTERNATE REGARDING CLEANING, PRIMING AND PAINTING OF GAS PIPING, HOT STACKS AND EMERGENCY ENGINE
- ALL GAS, CONDENSATE AND ELECTRICAL CONDUIT LINES TO BE SUPPORTED PER DETAILS.
- REPLACE MISSING SPLASH BLOCKS AT OUTLET OF ANY DOWNSPOUTS THAT DRAIN ONTO ROOF AREAS.

Legend

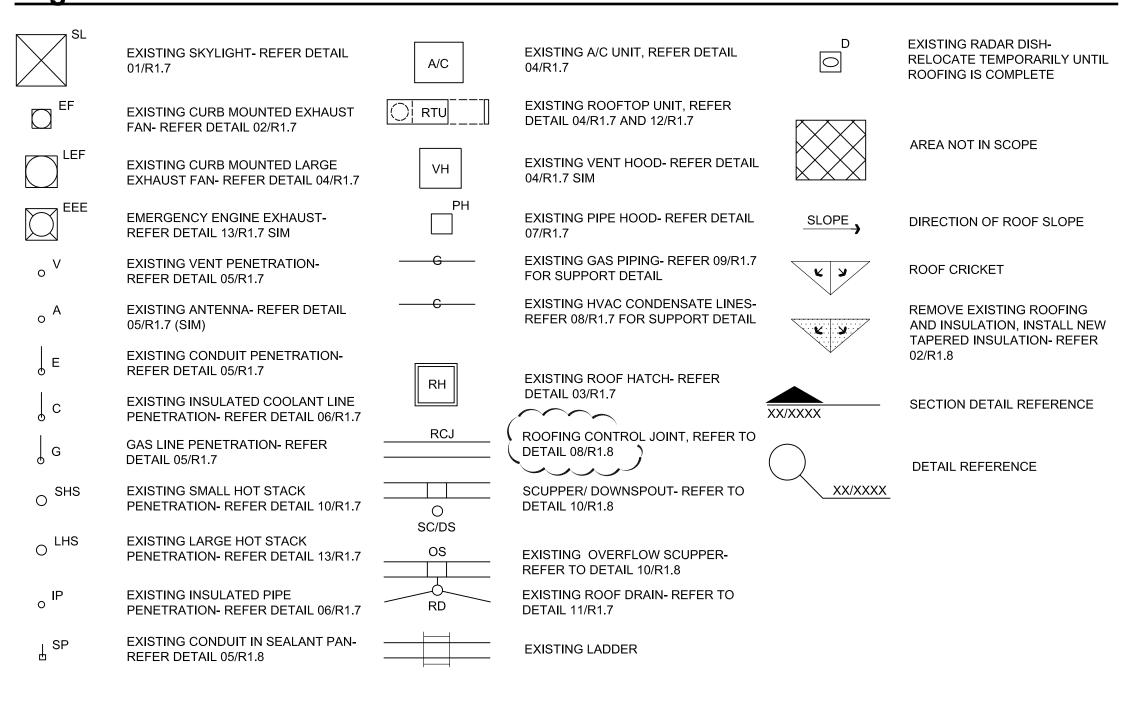



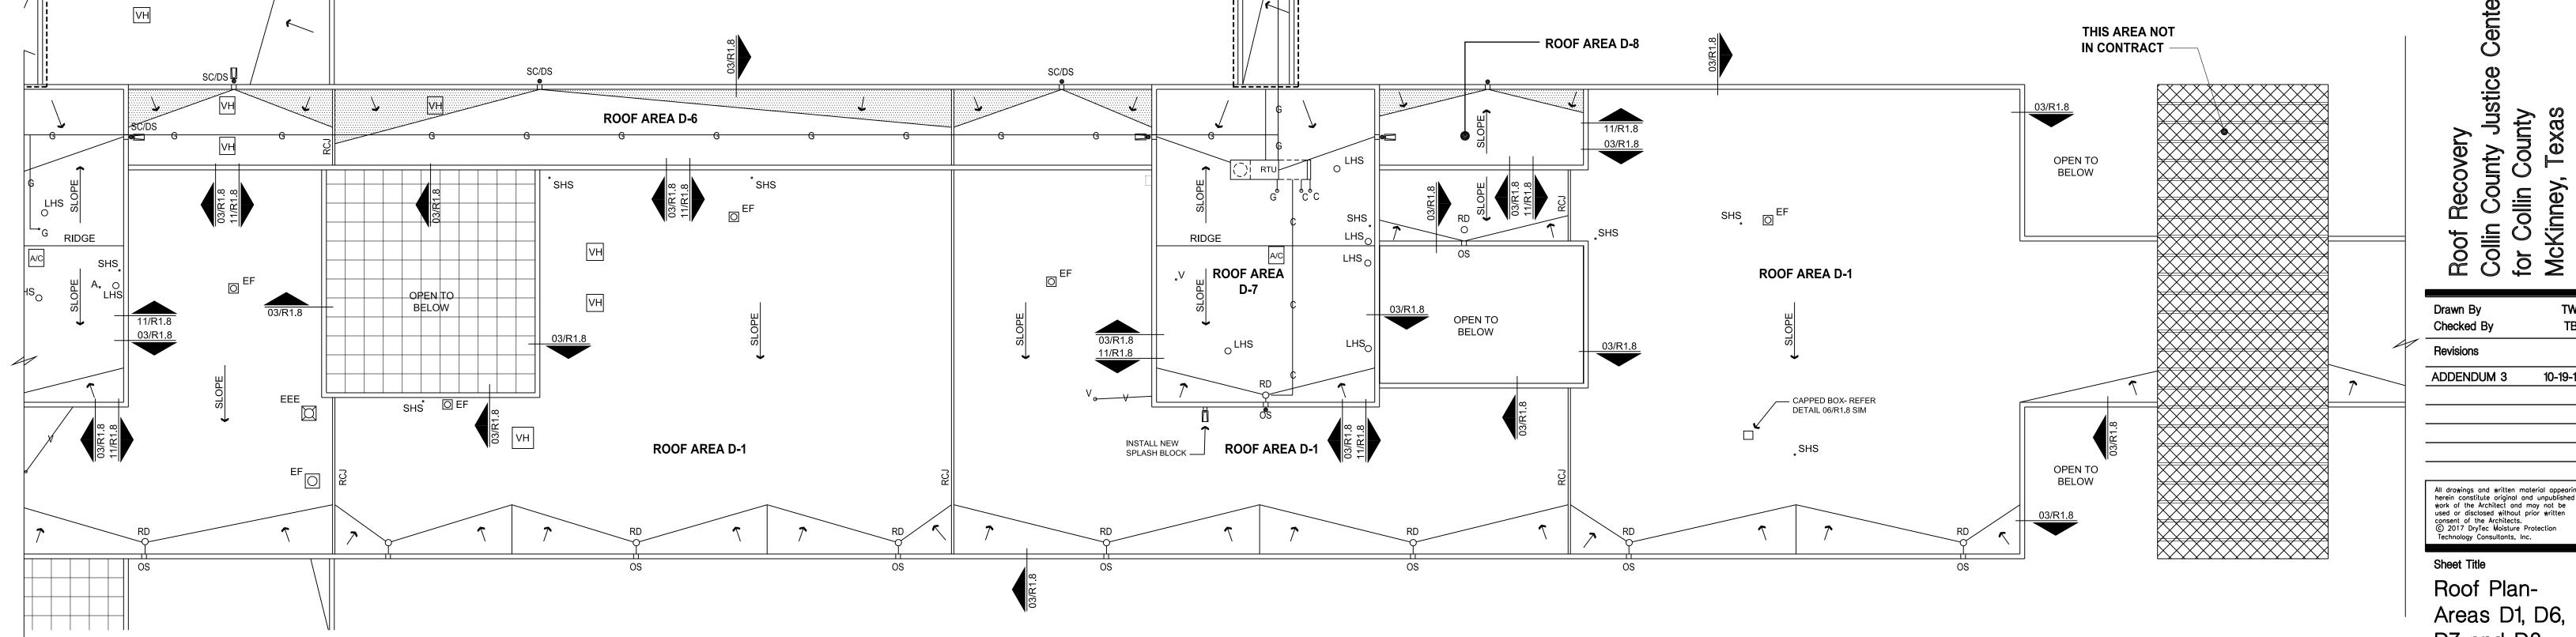

Checked By ADDENDUM 3

used or disclosed without prior written consent of the Architects.

© 2017 DryTec Moisture Protection Technology Consultants, Inc.

Roof Plan-Areas D1, D6, D7 and D8

Project Number 46-17026N AS NOTED 08/28/17

New Construction General Notes

- REFER DEMOLITION PLANS FOR REPLACEMENT OF EXISTING MOISTURE DAMAGED INSULATION AND PREPARATION OF EXISTING ROOFING TO RECEIVE NEW ROOFING.
- CUT 6" LONG SLITS THROUGH CAP SHEET AND BASE PLY AT 3 FOOT ON CENTER BOTH WAYS IN ENTIRE ROOF RECOVERY AREA.
- SECURE ALL LOOSE EXISTING VENT HOODS.
 PROVIDE NEW WET-SEALING OF ALL EXISTING EXTERIOR SKYLIGHTS IN ACCORDANCE WITH SPECIFICATIONS SECTION 08 8900.

NEW ROOF RECOVERY SYSTEM

ALL ROOF AREAS (EXCEPT AS NOTED BELOW):

- MINERAL SURFACED SBS MODIFIED BITUMEN ROOF MEMBRANE TORCH APPLIED OVER UNSURFACED BASE PLY TORCH APPLIED OVER PRIMED SURFACE OF EXISTING MODIFIED BITUMEN CAP SHEET AFTER ALL WET MATERIALS HAVE BEEN REMOVED AND REPLACED AND AFTER 6" SLITS ARE CUT INTO THE EXISTING ROOF SYSTEM THROUGH THE ROOFING MEMBRANE.
- NOTE THAT ALL EXISTING BASE FLASHINGS ARE TO BE REMOVED AND REPLACED.
- INSTALL NEW BASE FLASHINGS IN ALL LOCATIONS PER DETAILS.
 REMOVE ALL SHEET METAL COUNTER FLASHINGS.
- INSTALL NEW MEMBRANE AND COUNTER FLASHING AT ALL COPINGS PER DETAILS.

NOTICE TO OWNER PRIOR TO REMOVING AND RAISING CONDUITS AND PIPING.

- REMOVE ALL SHEET METAL "CONES" FROM EXISTING ROOF PENETRATATIONS.
- ROOFTOP HVAC UNITS: RAISE CURB HEIGHTS AS REQUIRED TO PROVIDE MINIMUM 8" FLASHING HEIGHT. WORK TO INCLUDE DISCONNECT OF EXISTING ELECTRICAL CONNECTIONS, GAS PIPING AND CONDENSATE LINES. EXTEND AND RECONNECT ELECTRICAL, GAS AND CONDENSATE
- CONNECTIONS. PROVIDE 48 HOUR NOTICE TO OWNER PRIOR TO TAKING ANY UNIT OUT OF SERVICE.


 GAS PIPING, ELECTRICAL CONDUITS AND CONDENSATE DRAIN PIPING: RAISE SUCH PIPING TO ACCOMMODATE THE INSTALLATION OF NEW ROOF SYSTEM. RECONNECT SUCH PIPING AS REQUIRED TO PROVIDE FUNCTIONING SYSTEM. INSTALL PIPE SUPPORTS AS SPECIFIED. PROVIDE 48 HOUR

NEW ROOFING SYSTEM


ROOF AREAS A7, A8, B9, B10, C7 AND C8:

- MINERAL SURFACED SBS MODIFIED BITUMEN ROOF MEMBRANE TORCH APPLIED OVER UNSURFACED BASE PLY TORCH APPLIED OVER ½" GYPSUM SHEATHING ADHERED TO ¾" MINIMUM THICKNESS ¼" PER FOOT TAPERED POLYISOCYANURATE INSULATION ADHERED TO 2" THICK POLYISOCYANURATE INSULATION MECHANICALLY FASTENED TO EXISTING DECK. FORM CRICKETS WITH ½" PER FOOT TAPERED POLYISOCYANURATE INSULATION.
- ALL SIGHT EXPOSED ROOFING RELATED SHEET METAL VISIBLE FROM GROUND LEVEL TO BE FORMED OUT OF PRE-FINSHED SHEET METAL.
- ALL NON SIGHT EXPOSED ROOFING RELATED SHEET METAL NOT VISIBLE FROM GROUND LEVEL TO BE FORMED OUT OF GALVANIZED SHEET METAL.
- PROVIDE WALK PADS AT THE BASE AND THE TOP OF ALL ROOF ACCESS LADDERS AND THREE SIDES OF ROOF HATCH.
 INSTALL INSULATION CRICKETS ON THE HIGH SIDE OF ALL ROOF CURBS.
- REFER SPECIFICATIONS FOR PRICING ALTERNATE REGARDING CLEANING, PRIMING AND PAINTING OF GAS PIPING, HOT STACKS AND EMERGENCY ENGINE EXHAUST.
- ALL GAS, CONDENSATE AND ELECTRICAL CONDUIT LINES TO BE SUPPORTED PER DETAILS.
 REPLACE MISSING SPLASH BLOCKS AT OUTLET OF ANY DOWNSPOUTS THAT DRAIN ONTO ROOF AREAS.

Legend

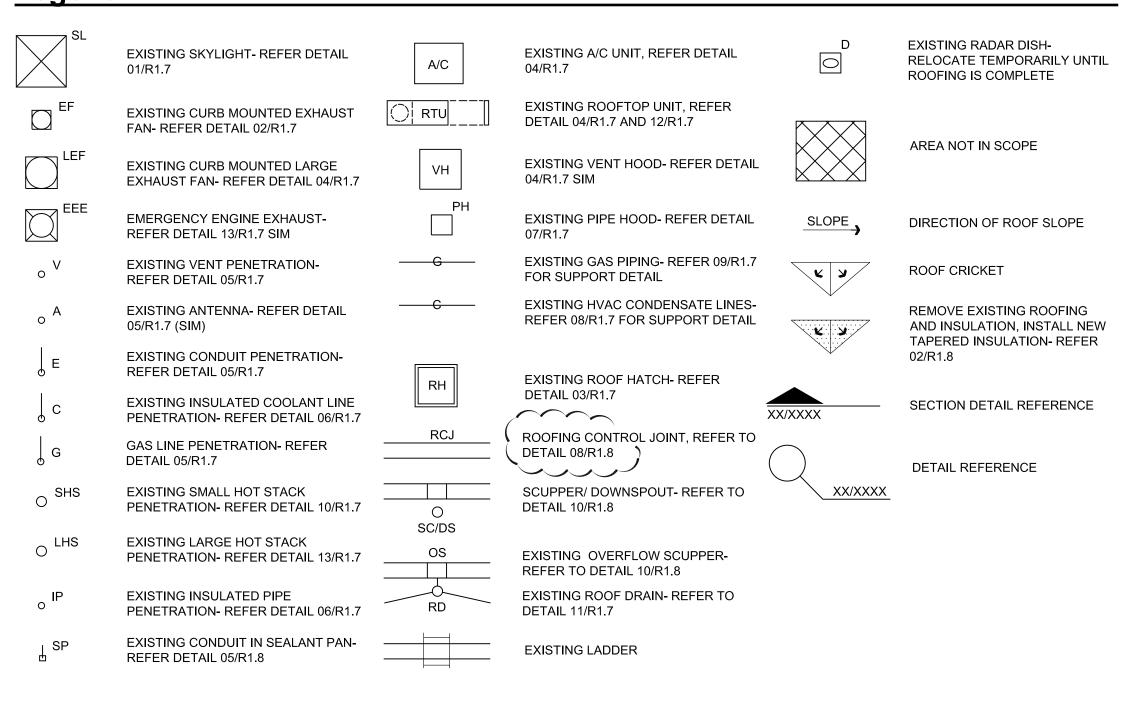



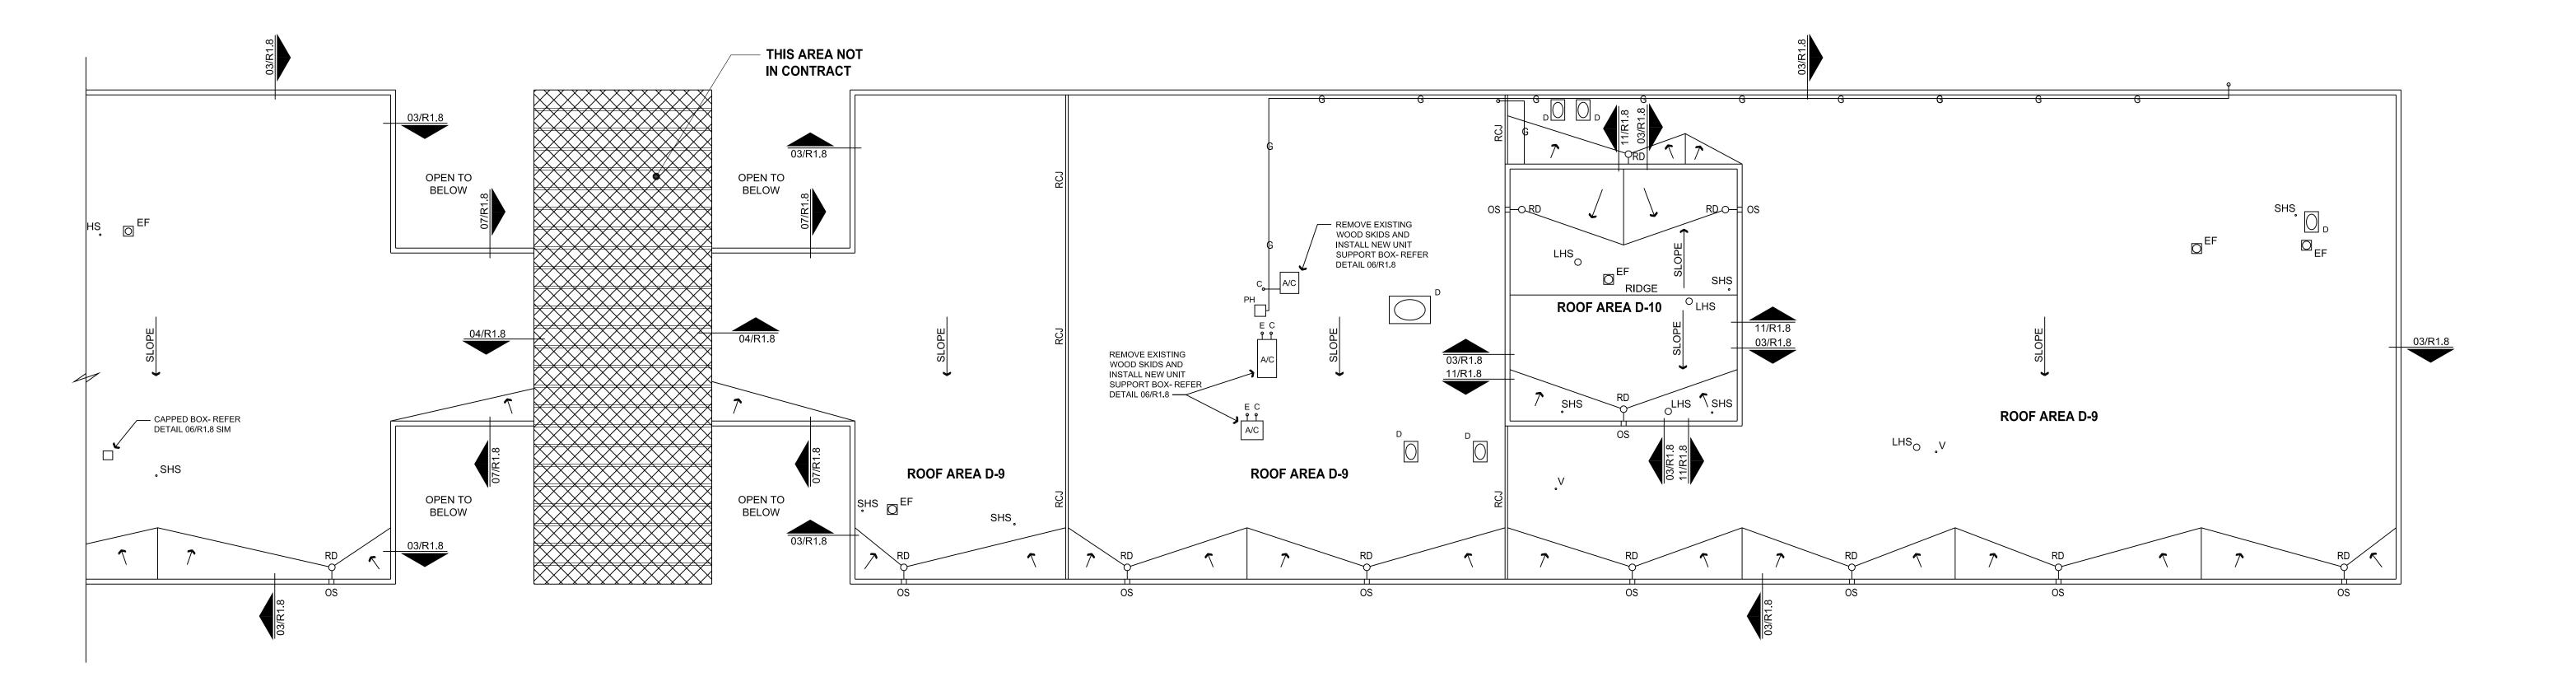

Collin County Justice Center for Collin County
McKinney, Texas

Drawn By TW
Checked By TB
Revisions
ADDENDUM 3 10-19-17


All drawings and written material appearing herein constitute original and unpublished work of the Architect and may not be used or disclosed without prior written consent of the Architects.

© 2017 DryTec Moisture Protection Technology Consultants, Inc.


Sheet Title
Roof PlanAreas D9, D10

_		
	Project Number	46-170261
•	Scale:	AS NOTED
•	Date	08/28/17

Sheet No. R1.6

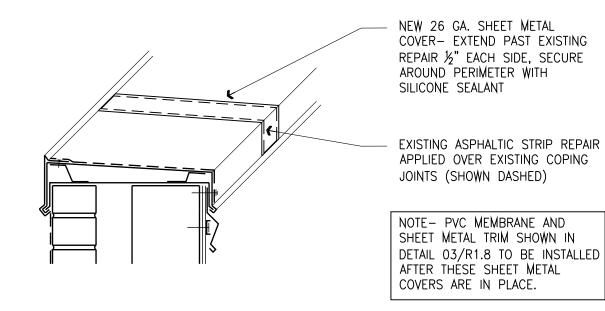



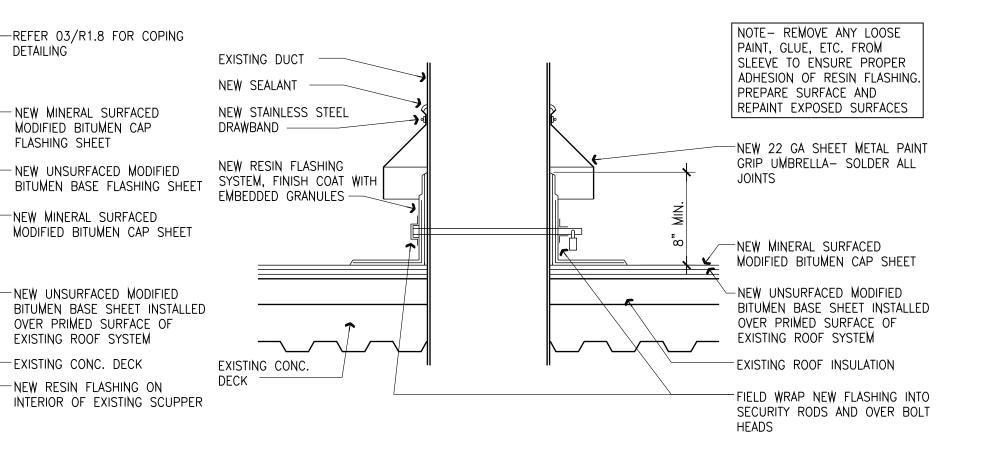

N AREAS WHERE EXISTING COPING IS SAGGING IN CENTER, SUPPLEMENT WITH NEW CONTINUOUS 22 GA PREFINISHED SHEET METAL SUPPORT AT MID SPAN AS SHOWN. FASTEN THROUGH EXISTING SHEET METAL COPING SUPPORT WITH FASTENERS WITH NEOPRENE WASHERS

NEW 22 GA. GALV. SHEET

FASTENERS WITH RUBBER

OVER PRIMED SURFACE OF

EXISTING ROOF SYSTEM

BITUMEN CAP SHEET

WASHERS

12 Coping Support Detail Scale: 3" = 1'-0"

NEW MINERAL SURFACED

MODIFIED BITUMEN CAP

BASE FLASHING SHEET

NEW CONT. CANT STRIP


EXISTING INSULATION -

EXISTING CONC. DECK

FLASHING SHEET -

NEW UNSURFACED

MODIFIED BITUMEN

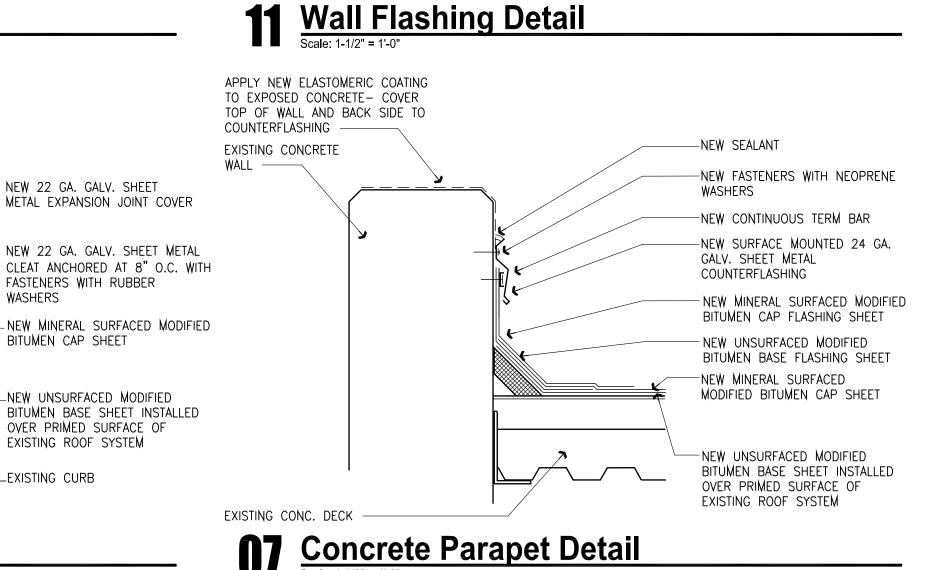

EXISTING CONC.
DECK

REFER DETAIL 13/R1.8 FOR REPAIR TO

THERE WILL BE NO PONDING ON COPING

IN ANY LOCATIONS. REFER DETAIL 12/R1.8

EXISTING FACE BRICK

GALV. SHEET METAL

BASE FLASHING SHEET

BITUMEN CAP SHEET

COUNTERFLASHING

-NEW FASTENERS WITH NEOPRENE

-NEW SURFACE MOUNTED 24 GA.

- NEW MINERAL SURFACED MODIFIED

-NEW MINERAL SURFACED MODIFIED

NEW UNSURFACED MODIFIED BITUMEN

NEW UNSURFACED MODIFIED BITUMEN

BASE SHEET INSTALLED OVER PRIMED

SURFACE OF EXISTING ROOF SYSTEM


BITUMEN CAP FLASHING SHEET

-NEW CONTINUOUS TERM BAR

-NEW SEALANT

WASHERS

Expansion Joint Detail

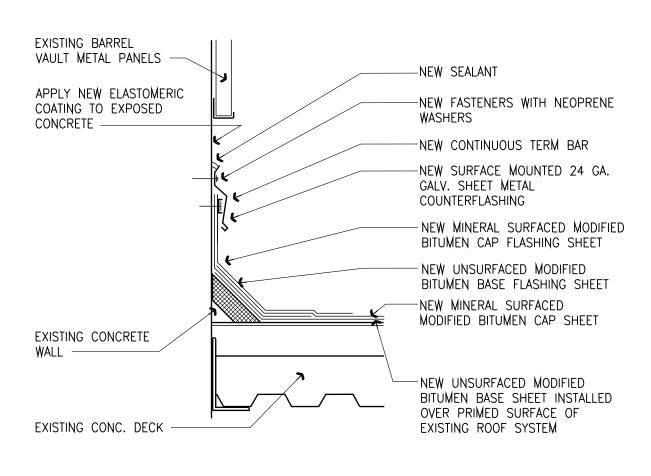

Mall Flashing DetailScale: 1-1/2" = 1'-0"

REMEDIAL PATCHES BEFORE APPLICATION -EXISTING PREFINISHED SHEET OF PVC MEMBRANE METAL COPING TO REMAIN NEW 60 MIL FULLY ADHERED PVC -NEW FASTENERS WITH NEOPRENE MEMBRANE ON EXISTING COPING- LAP OVER SHEET METAL TRIM AND DOWN WASHERS BACK SIDE OF EXISTING COPING --NEW CONTINUOUS TERM BAR -NEW 24 GA. GALV. SHEET PREFINISHED SHEET METAL COUNTERFLASHING-METAL TRIM- LOCK TUCK BEHIND EXISTING COPING OVER EDGE OF EXISTING COPING AND FASTEN NEW MINERAL SURFACED TOP EDGE -MODIFIED BITUMEN CAP FLASHING SHEET NEW WATER REPELLANT NEW UNSURFACED MODIFIED TO ONE COURSE BELOW BITUMEN BASE FLASHING SHEET WEEPS (COORDINATE WITH ELEVATIONS) --NEW MINERAL SURFACED MODIFIED BITUMEN CAP SHEET EXISTING THROUGH-WALL NEW UNSURFACED MODIFIED FLASHING AND WEEPS BITUMEN BASE SHEET INSTALLED OVER PRIMED SURFACE OF EXISTING INSULATION -EXISTING ROOF SYSTEM NOTE: SHORE UP ANY AREAS OF EXISTING NOTE: AT LOCATIONS WHERE -EXISTING CONC. DECK COPING THAT DO NOT PROVIDE POSITIVE THERE IS LESS THAN 5" FROM SLOPE TOWARDS ROOF. ENSURE THAT EXISTING COPING TO TOP OF

ROOFING, TRANSITION CANT STRIP


TO ZERO.

Typical Parapet Detail

Scale: 1-1/2" = 1'-0"

Scupper Detail
Scale: 1-1/2" = 1'-0"


RESIN FLASHING

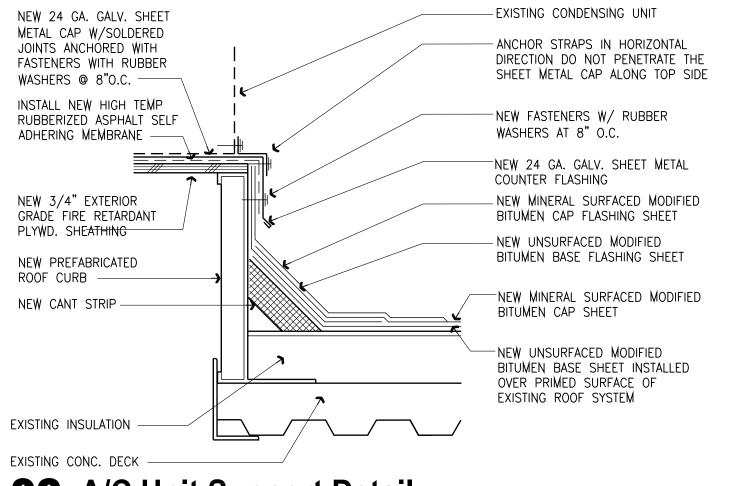

DETAILING


FLASHING SHEET

16 A/C Unit Support Detail

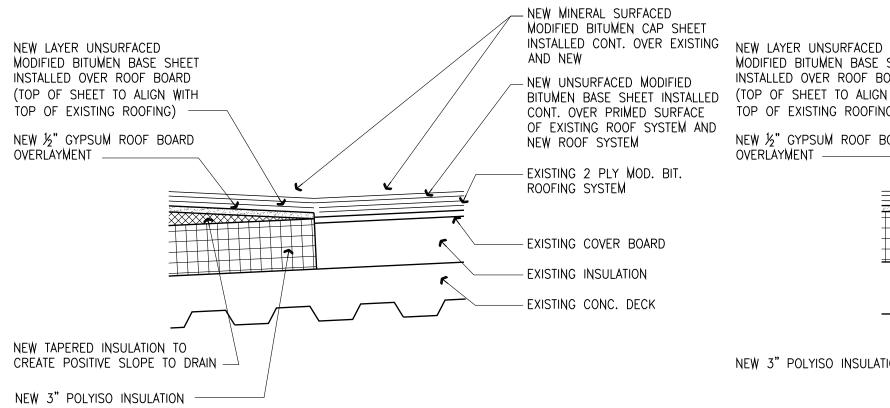


O2 Supplemental Insulation Detail

19 Duct Penetration Detail Scale: 1-1/2" = 1'-0"

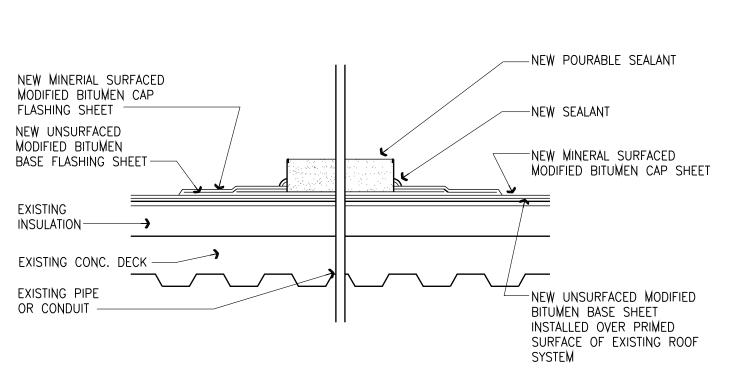

05 Existing Sealant Pan Detail

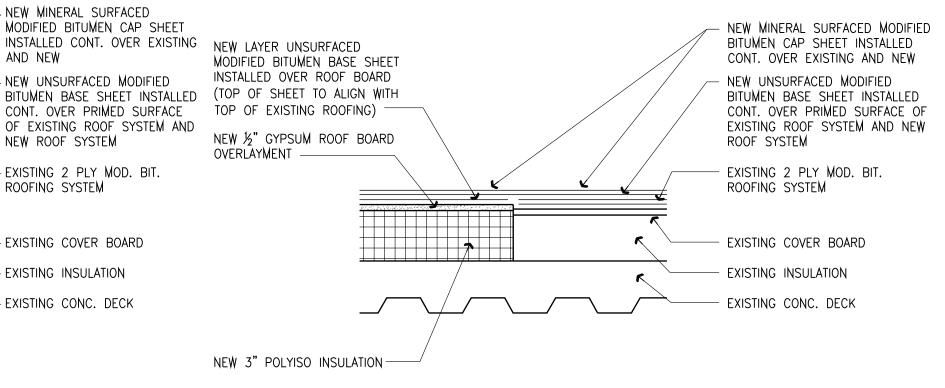

11 Existing Roofing Infill Detail

Suite 1730 Dallas, Texas 214-363-2192 Voice 214-363-2193 Fax Date of Signing October 19, 2017

DryTec

Moisture Protection

Consultants, Inc.

8750 N. Central Expwy,

Technology

Julin County Just Collin County Roof F Collin for Co

Drawn By Checked By	TW TB
Revisions	
ADDENDUM 2	10-13-1
ADDENDUM 3	10-19-1

All drawings and written material appearing herein constitute original and unpublishe work of the Architect and may not be work of the Architects used or disclosed without prior written consent of the Architects.

© 2017 DryTec Moisture Protection Technology Consultants, Inc.

Sheet Title **Roof Details**

Project Number	46-17026N
Scale:	AS NOTED
Date	08/28/17