New Construction General Notes

- REFER DEMOLITION PLANS FOR REPLACEMENT OF EXISTING MOISTURE DAMAGED INSULATION AND PREPARATION OF EXISTING ROOFING TO RECEIVE NEW ROOFING.
- CUT 6" LONG SLITS THROUGH CAP SHEET AND BASE PLY AT 3 FOOT ON CENTER BOTH WAYS IN ENTIRE ROOF RECOVERY AREA.
- SECURE ALL LOOSE EXISTING VENT HOODS.
 PROVIDE NEW WET-SEALING OF ALL EXISTING EXTERIOR SKYLIGHTS IN ACCORDANCE WITH SPECIFICATIONS SECTION 08 8900.

NEW ROOF RECOVERY SYSTEM

ALL ROOF AREAS (EXCEPT AS NOTED BELOW):


- MINERAL SURFACED SBS MODIFIED BITUMEN ROOF MEMBRANE TORCH APPLIED OVER UNSURFACED BASE PLY TORCH APPLIED OVER PRIMED SURFACE OF EXISTING MODIFIED BITUMEN CAP SHEET AFTER ALL WET MATERIALS HAVE BEEN REMOVED AND REPLACED AND AFTER 6" SLITS ARE CUT INTO THE EXISTING ROOF SYSTEM THROUGH THE ROOFING MEMBRANE.
- NOTE THAT ALL EXISTING BASE FLASHINGS ARE TO BE REMOVED AND REPLACED.
 INSTALL NEW BASE FLASHINGS IN ALL LOCATIONS PER DETAILS.
- REMOVE ALL SHEET METAL COUNTER FLASHINGS.
- INSTALL NEW MEMBRANE AND COUNTER FLASHING AT ALL COPINGS PER DETAILS.
- REMOVE ALL SHEET METAL "CONES" FROM EXISTING ROOF PENETRATATIONS.
 ROOFTOP HVAC UNITS: REFER DRAWINGS FOR UNITS THAT ARE TO BE RAISED FOR INSTALLATION OF NEW CURBS. WORK TO INCLUDE DISCONNECTION OF EXISTING ELECTRICAL CONNECTIONS, GAS PIPING AND CONDENSATE LINES. EXTEND AND RECONNECT ELECTRICAL, GAS AND CONDENSATE CONNECTIONS. PROVIDE 48 HOUR NOTICE TO OWNER PRIOR TO TAKING ANY UNIT OUT OF SERVICE.
- ELECTRICAL CONDUITS AND CONDENSATE DRAIN PIPING: RAISE SUCH PIPING TEMPORARILY TO ACCOMMODATE THE INSTALLATION OF NEW ROOF SYSTEM. RECONNECT SUCH PIPING AS REQUIRED TO PROVIDE FUNCTIONING SYSTEM. INSTALL PIPE SUPPORTS AS SPECIFIED. PROVIDE 48 HOUR NOTICE TO OWNER PRIOR TO DISCONNECTING ANY ELECTRICAL AND/OR PIPING IF REQUIRED.
- GAS PIPING SHOULD NOT NEED TO BE RAISED OR RELOCATED FOR RE-ROOFING. STAGE RE-ROOFING ACTIVITIES TO ALLOW REMOVAL AND REPLACEMENT OF GAS PIPE SUPPORTS AS REQUIRED SUCH THAT THE PIPING IS ADEQUATELY SUPPORTED WITHOUT THE NEED TO DISCONNECT OR MOVE PIPING.

NEW ROOFING SYSTEM

ROOF AREAS A7, A8, B9, B10, C7 AND C8:

- MINERAL SURFACED SBS MODIFIED BITUMEN ROOF MEMBRANE TORCH APPLIED OVER UNSURFACED BASE PLY TORCH APPLIED OVER ½" GYPSUM SHEATHING ADHERED TO ¾" MINIMUM THICKNESS ¼" PER FOOT TAPERED POLYISOCYANURATE INSULATION ADHERED TO 2" THICK POLYISOCYANURATE INSULATION MECHANICALLY FASTENED TO EXISTING DECK. FORM CRICKETS WITH ½" PER FOOT TAPERED POLYISOCYANURATE INSULATION.
- ALL SIGHT EXPOSED ROOFING RELATED SHEET METAL VISIBLE FROM GROUND LEVEL TO BE FORMED OUT OF PRE-FINSHED SHEET METAL.
- ALL NON SIGHT EXPOSED ROOFING RELATED SHEET METAL NOT VISIBLE FROM GROUND LEVEL TO BE FORMED OUT OF GALVANIZED SHEET METAL.
- PROVIDE WALK PADS AT THE BASE AND THE TOP OF ALL ROOF ACCESS LADDERS AND THREE SIDES OF ROOF HATCH.
- INSTALL INSULATION CRICKETS ON THE HIGH SIDE OF ALL ROOF CURBS.
 REFER SPECIFICATIONS FOR PRICING ALTERNATE REGARDING CLEANING, PRIMING AND PAINTING OF GAS PIPING, HOT STACKS AND EMERGENCY ENGINE
- ALL GAS, CONDENSATE AND ELECTRICAL CONDUIT LINES TO BE SUPPORTED PER DETAILS.
- REPLACE MISSING SPLASH BLOCKS AT OUTLET OF ANY DOWNSPOUTS THAT DRAIN ONTO ROOF AREAS.


Legend

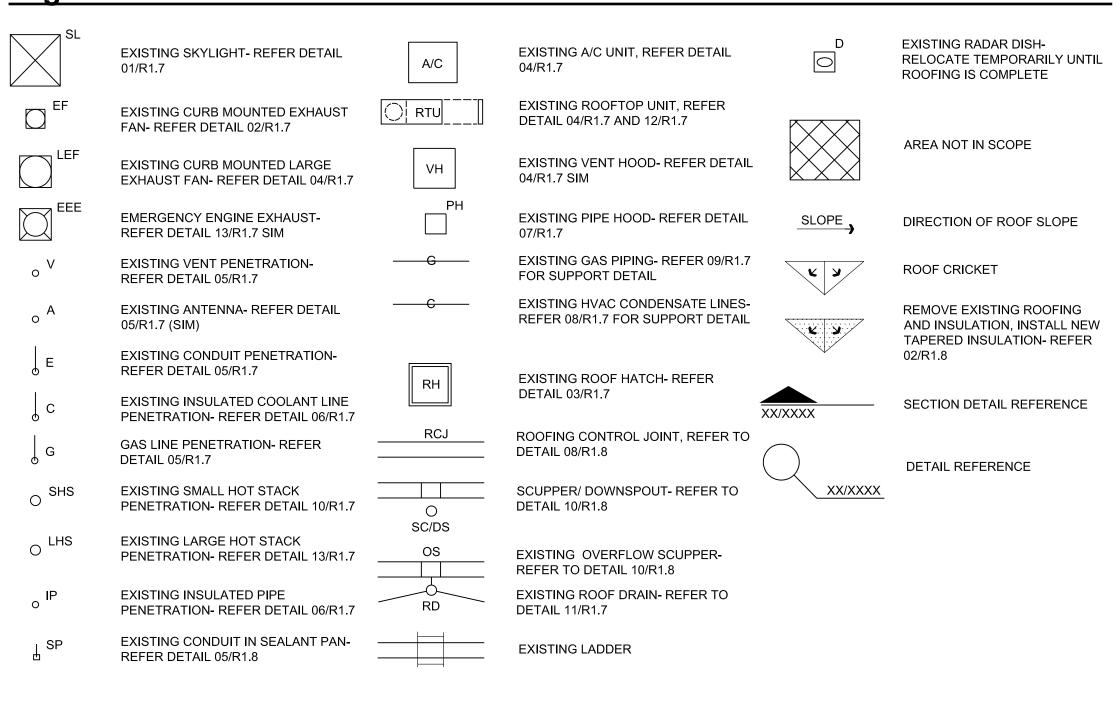



Consultants, Inc.
8750 N. Central Expwy,
Suite 1730
Dallas, Texas 75231
Voice 214-363-2192



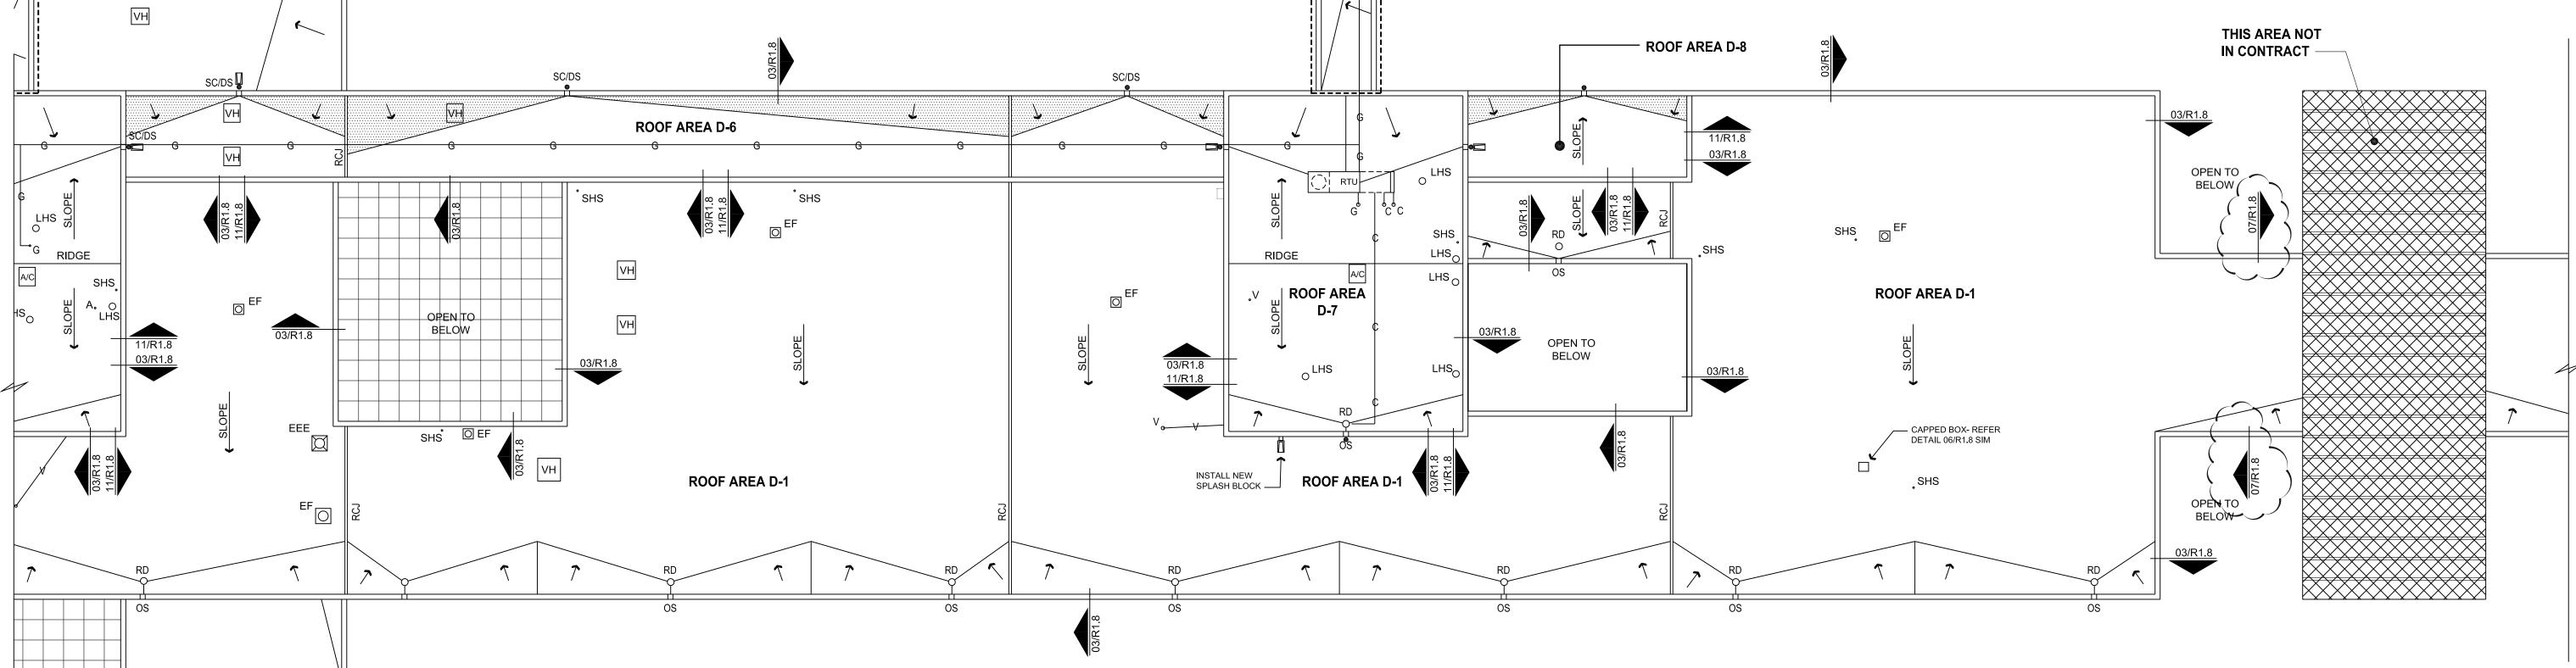

Hoof Hecovery
Collin County Justice Center
for Collin County

Checked By TB

Revisions

ADDENDUM 1 02-08-18

All drawings and written material appearing herein constitute original and unpublished work of the Architect and may not be used or disclosed without prior written consent of the Architects.

© 2017 DryTec Moisture Protection Technology Consultants, Inc.

Sheet Title
Roof PlanAreas D1, D6,
D7 and D8

Project Number 46-17026N

Scale: AS NOTED

Date 12/20/17

Sheet No. R1.5